


USC CAMPUS PLANNING AND CONSTRUCTION 1300 PICKENS STREET COLUMBIA, SOUTH CAROLINA 29208 BARRINGER HOUSE RENOVATIONS

STATE PROJECT #FP00000285 GMK PROJECT # 16070.03/H27-D339-ID **AUGUST 2, 2019** ISSUED FOR **CONSTRUCTION DOCUMENTS**


Prepared by:



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date

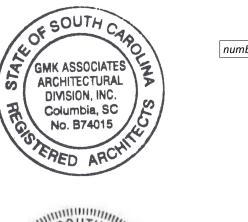

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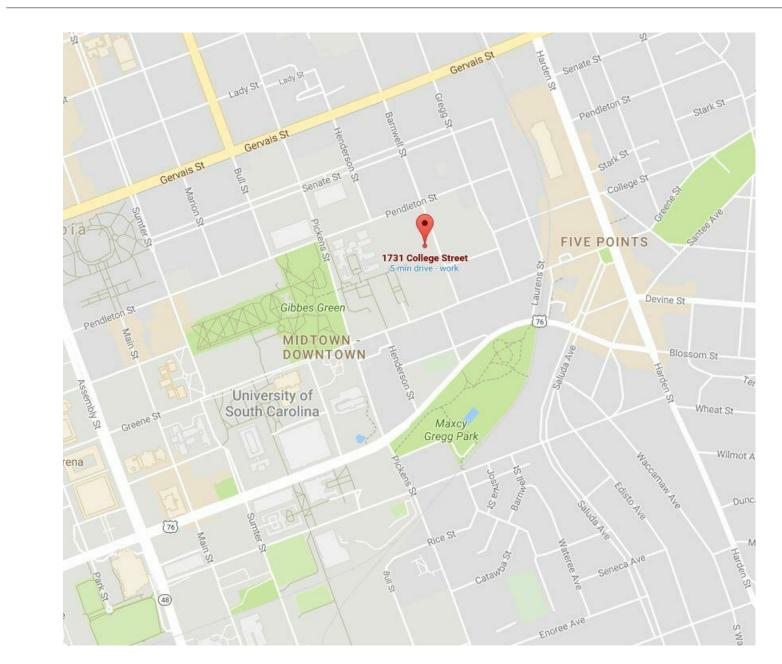
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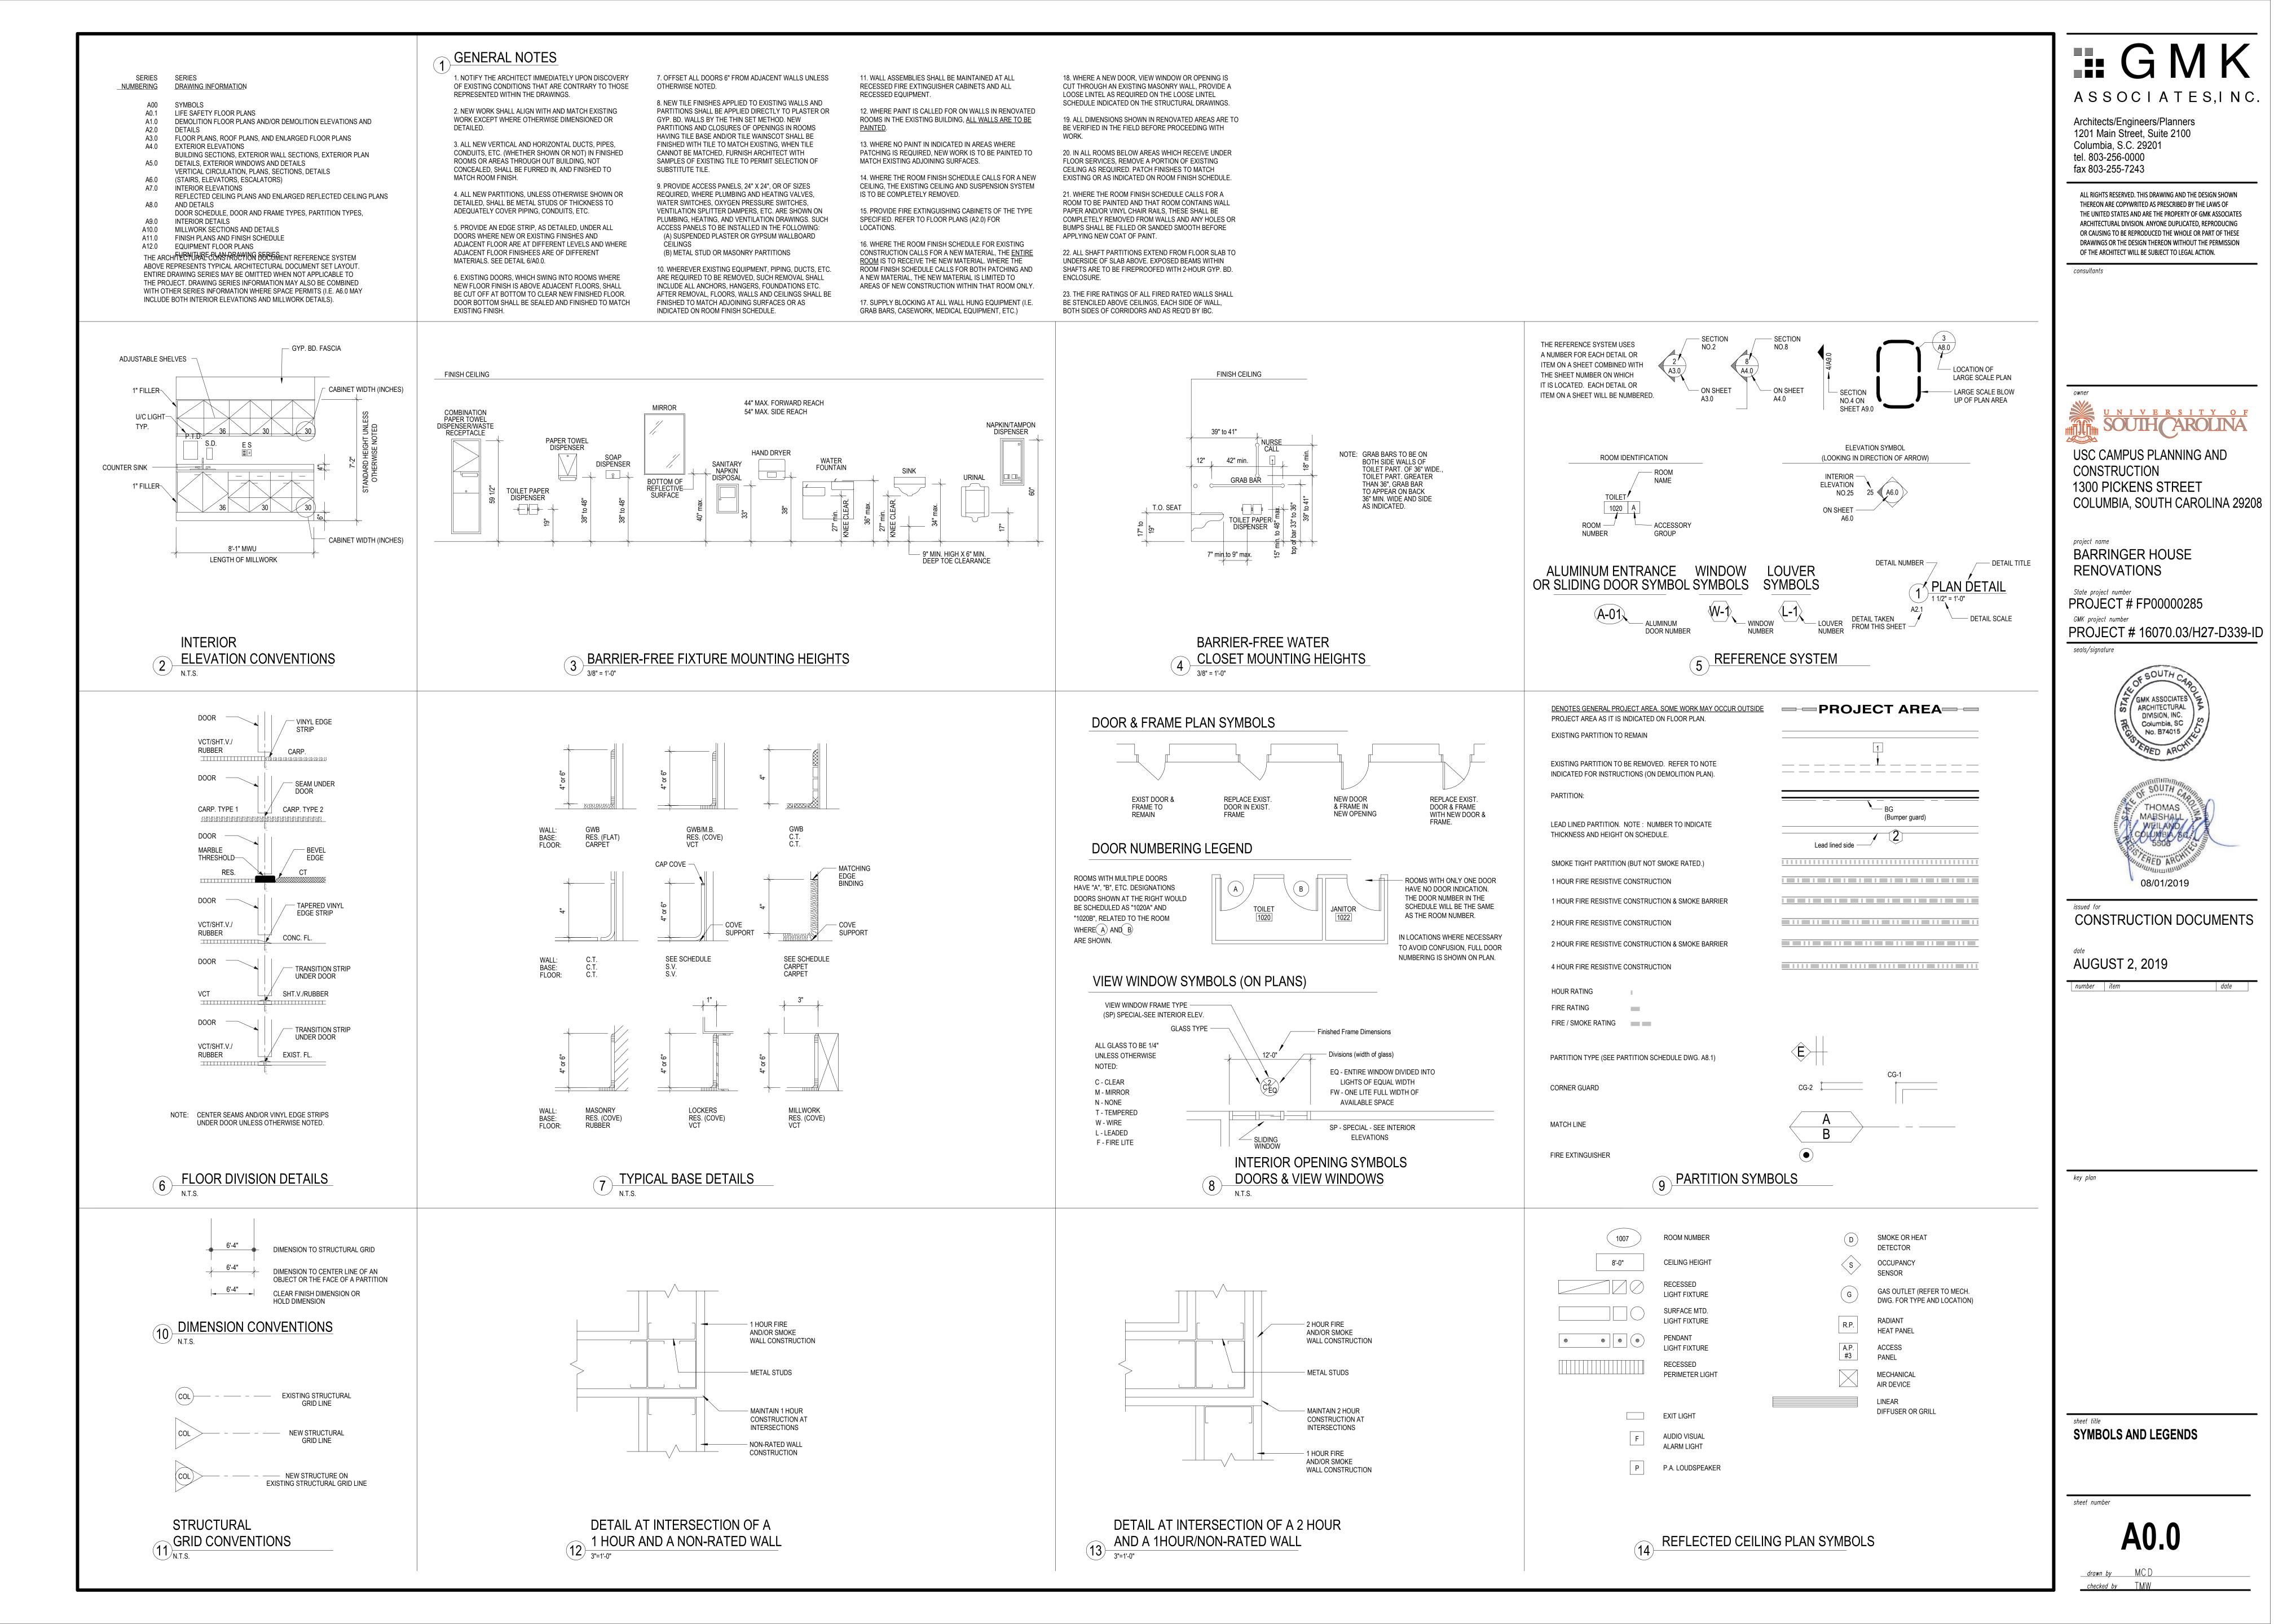
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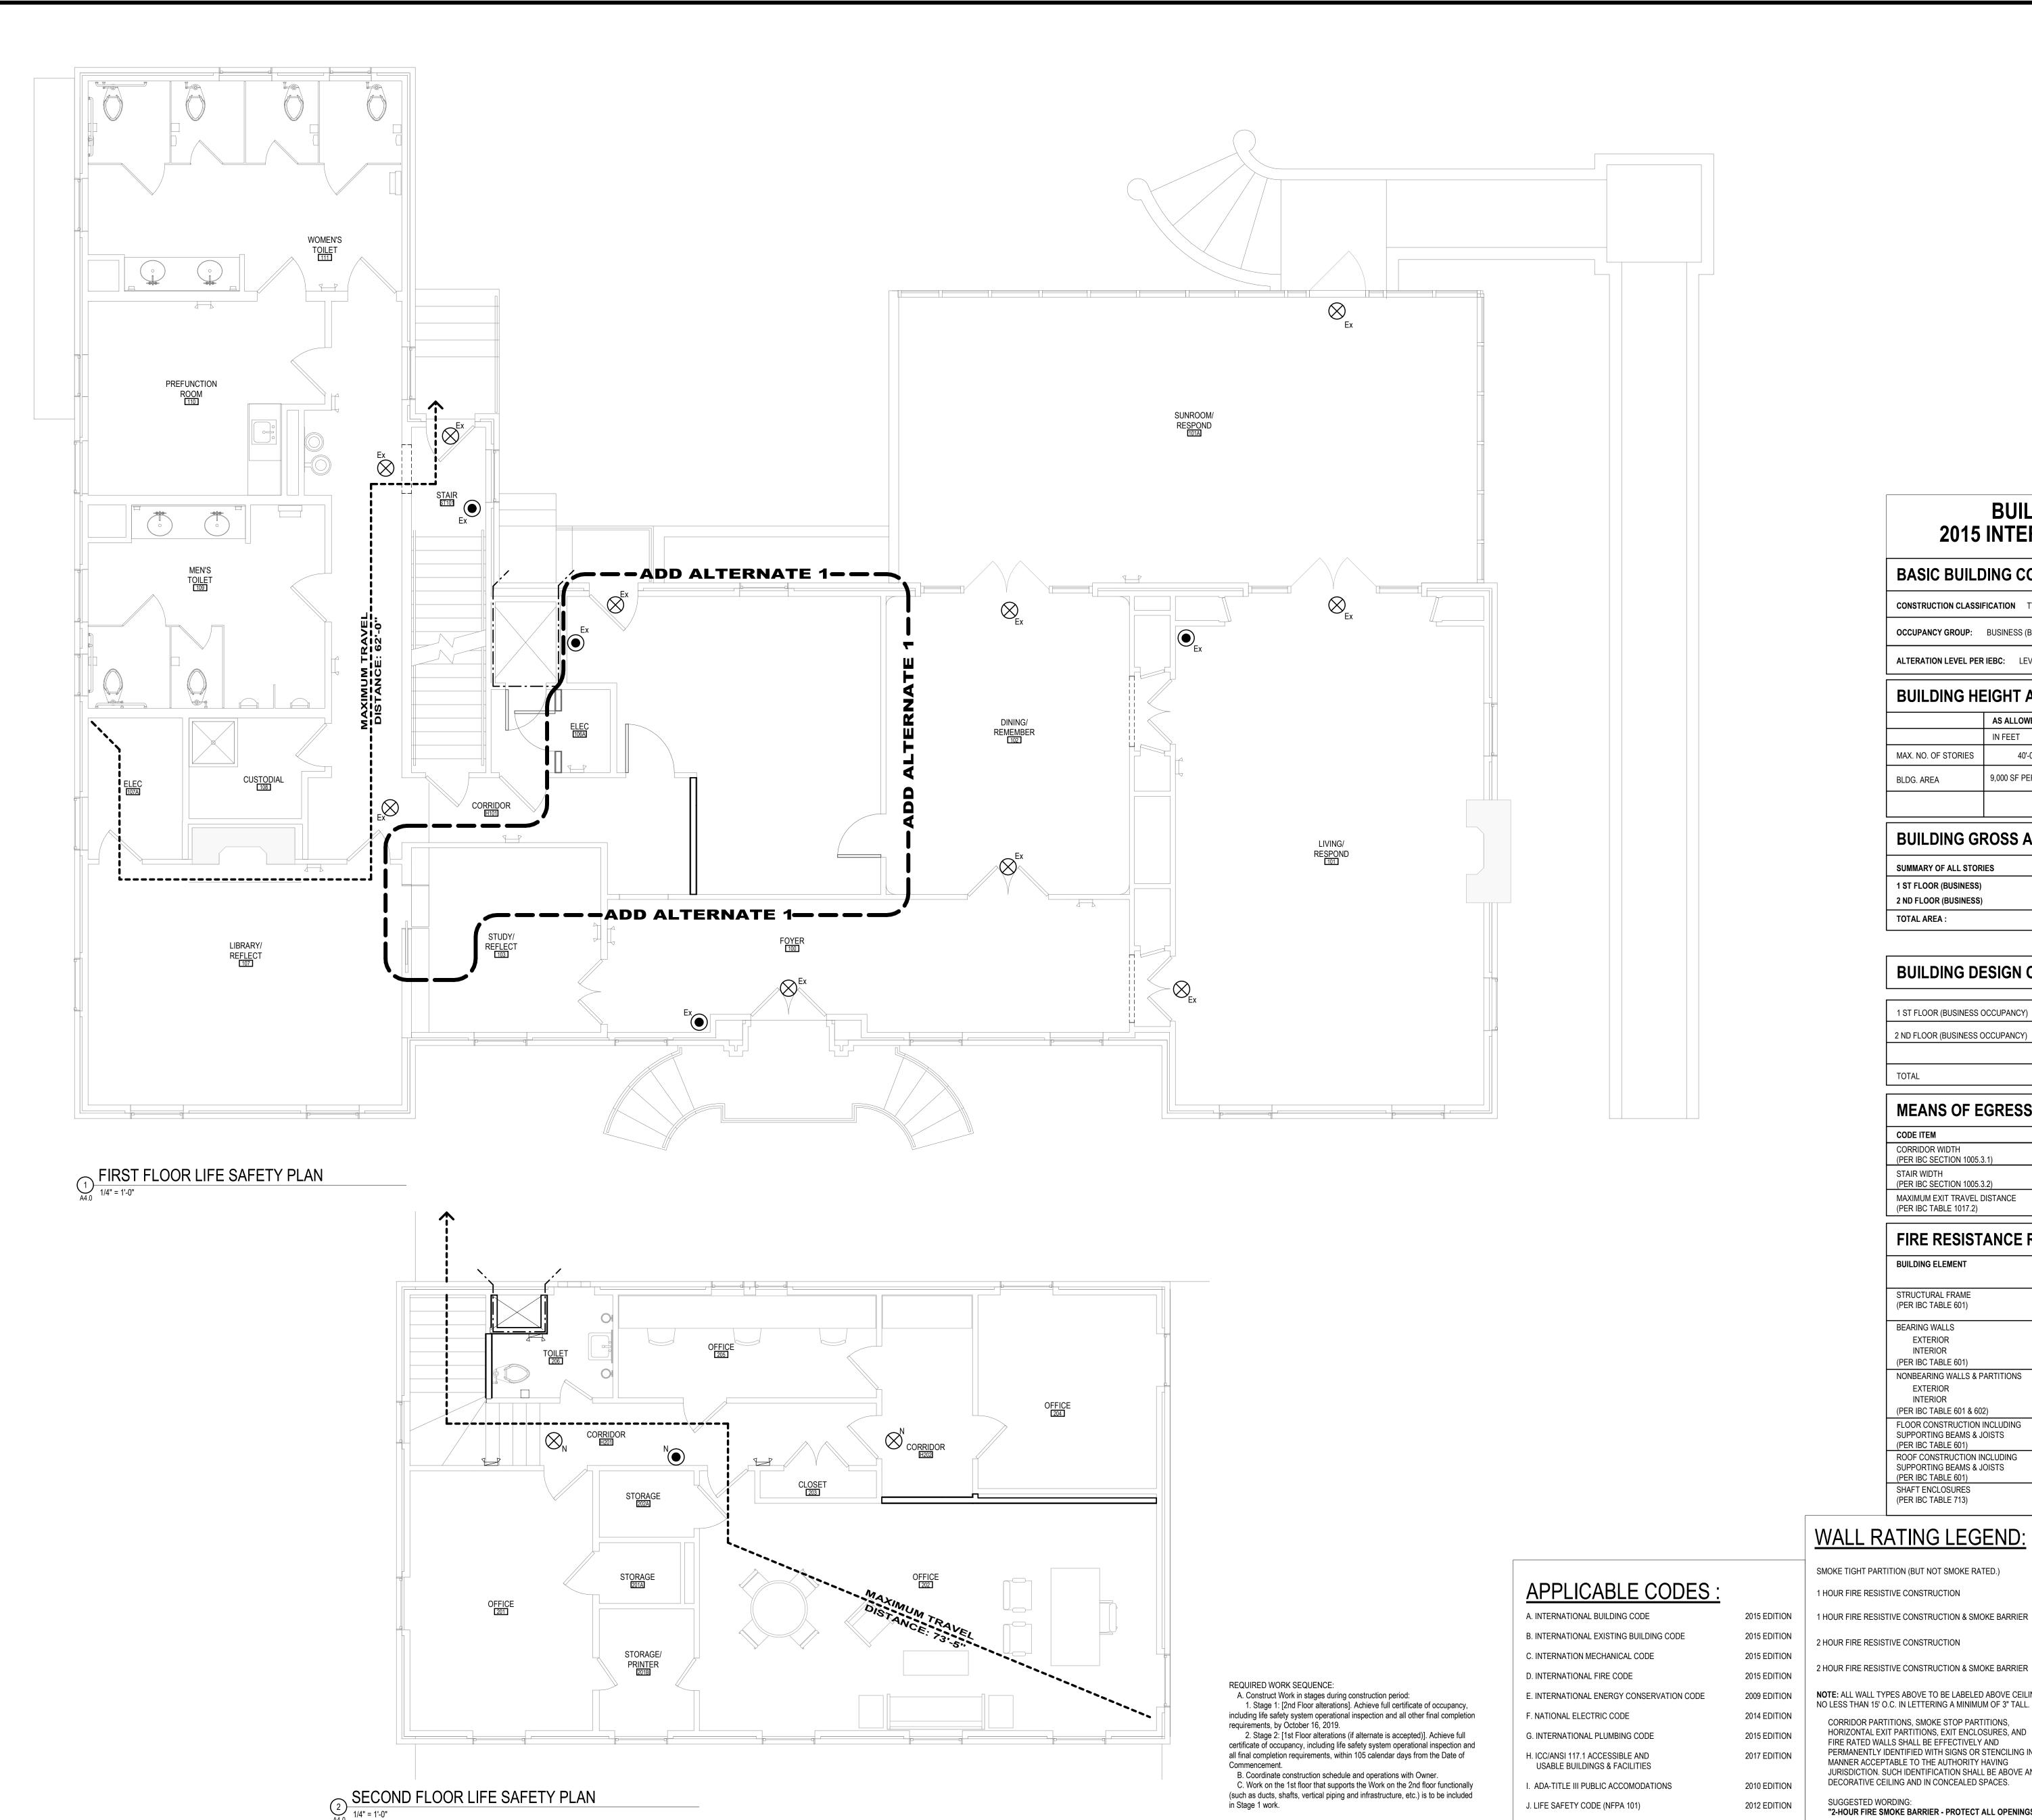
ELECTRICAL
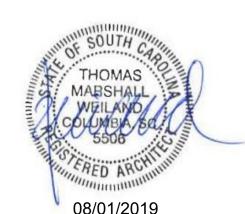
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VICINITY PLAN







BUILDING CODE ANALYSIS 2015 INTERNATIONAL BUILDING CODE

BASIC BUILDING CODE INFORMATION

CONSTRUCTION CLASSIFICATION TYPE: V (NON-SPRINKLED)

OCCUPANCY GROUP: BUSINESS (B)

ALTERATION LEVEL PER IEBC: LEVEL 2

BUILDING HEIGHT AND BUILDING AREA (PER IBC 504.3 & 506.2)

	AS ALLOWED BY IBC		AS DESIGNED		
	IN FEET	IN STORIES	IN FEET	IN STORIES	
MAX. NO. OF STORIES	40'-0"	2	39'-0"	2	
BLDG. AREA	9,000 SF PER STORY		3,950 SF (1ST FLOOR)		
			1,360 SF (2ND FLOOR)		

BUILDING GROSS AREA CALCULATION

SUMMARY OF ALL STORIES		
1 ST FLOOR (BUSINESS)	3,950 SF	
2 ND FLOOR (BUSINESS)	1,360 SF	
TOTAL AREA :	5,310 SF	(SUMMARY OF ALL STORIES)

(PER IBC TABLE 1004.1.2)	

1 ST FLOOR (BUSINESS OCCUPANCY)	3,950 SF	100 GROSS	39.5 - (39 PEOPLE)
2 ND FLOOR (BUSINESS OCCUPANCY)	1,360 SF	100 GROSS	13.6 - (13 PEOPLE)
TOTAL	5,310 SF		54 PEOPLE

MEANS OF EGRESS

CODE ITEM	REQUIRED	PROVIDED	NOTES
CORRIDOR WIDTH (PER IBC SECTION 1005.3.1)	44"	52"	54 (PEOPLE) X 0.2 = 10.8", OR 44" (WHICHEVER LARGER)
STAIR WIDTH (PER IBC SECTION 1005.3.2)	44"	54"	54 (PEOPLE) X 0.3 = 16.2", OR 44" (WHICHEVER LARGER)
MAXIMUM EXIT TRAVEL DISTANCE (PER IBC TABLE 1017.2)	200'	93'-7"	

FIRE RESISTANCE RATING OF BLDG ELEMENTS

BUILDING ELEMENT	RATING AS REQUIRED (IN HOURS)	RATING AS DESIGNED (IN HOURS)
STRUCTURAL FRAME (PER IBC TABLE 601)	0 HR	0 HR
BEARING WALLS EXTERIOR INTERIOR (PER IBC TABLE 601)	N/A HR N/A HR	N/A HR N/A HR
NONBEARING WALLS & PARTITIONS EXTERIOR INTERIOR (PER IBC TABLE 601 & 602)	0 HR 0 HR	0 HR 0 HR
FLOOR CONSTRUCTION INCLUDING SUPPORTING BEAMS & JOISTS PER IBC TABLE 601)	0 HR	0 HR
ROOF CONSTRUCTION INCLUDING SUPPORTING BEAMS & JOISTS (PER IBC TABLE 601)	0 HR	0 HR
SHAFT ENCLOSURES (PER IBC TABLE 713)	1 HR	1 HR

WALL RATING LEGEND:

SMOKE TIGHT PARTITION (BUT NOT SMOKE RATED.) 1 HOUR FIRE RESISTIVE CONSTRUCTION

1 HOUR FIRE RESISTIVE CONSTRUCTION & SMOKE BARRIER

2 HOUR FIRE RESISTIVE CONSTRUCTION

K. ANY OTHER CODE GOVERNED BY INDUSTRY STANDARDS


NOTE: ALL WALL TYPES ABOVE TO BE LABELED ABOVE CEILINGS NO LESS THAN 15' O.C. IN LETTERING A MINIMUM OF 3" TALL. CORRIDOR PARTITIONS, SMOKE STOP PARTITIONS,

HORIZONTAL EXIT PARTITIONS, EXIT ENCLOSURES, AND FIRE RATED WALLS SHALL BE EFFECTIVELY AND PERMANENTLY IDENTIFIED WITH SIGNS OR STENCILING IN A MANNER ACCEPTABLE TO THE AUTHORITY HAVING JURISDICTION. SUCH IDENTIFICATION SHALL BE ABOVE ANY DECORATIVE CEILING AND IN CONCEALED SPACES.

SUGGESTED WORDING: "2-HOUR FIRE SMOKE BARRIER - PROTECT ALL OPENINGS."

---- MAXIMUM TRAVEL DISTANCE PATH

SEE SHEET A4.0 FOR PARTITION CONSTRUCTION & RATINGS

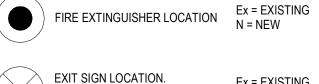

Ex = EXISTING SEE ELECTRICAL DWGS. N = NEW

EMERGENCY EXIT LIGHT. SEE ELECTRICAL DWGS.

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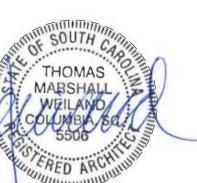
BARRINGER HOUSE RENOVATIONS

State project number PROJECT # FP00000285

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seals/signature






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AUGUST 2, 2019

LIFE SAFETY PLAN - FIRST AND

SECOND FLOORS

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BARRINGER HOUSE **RENOVATIONS**

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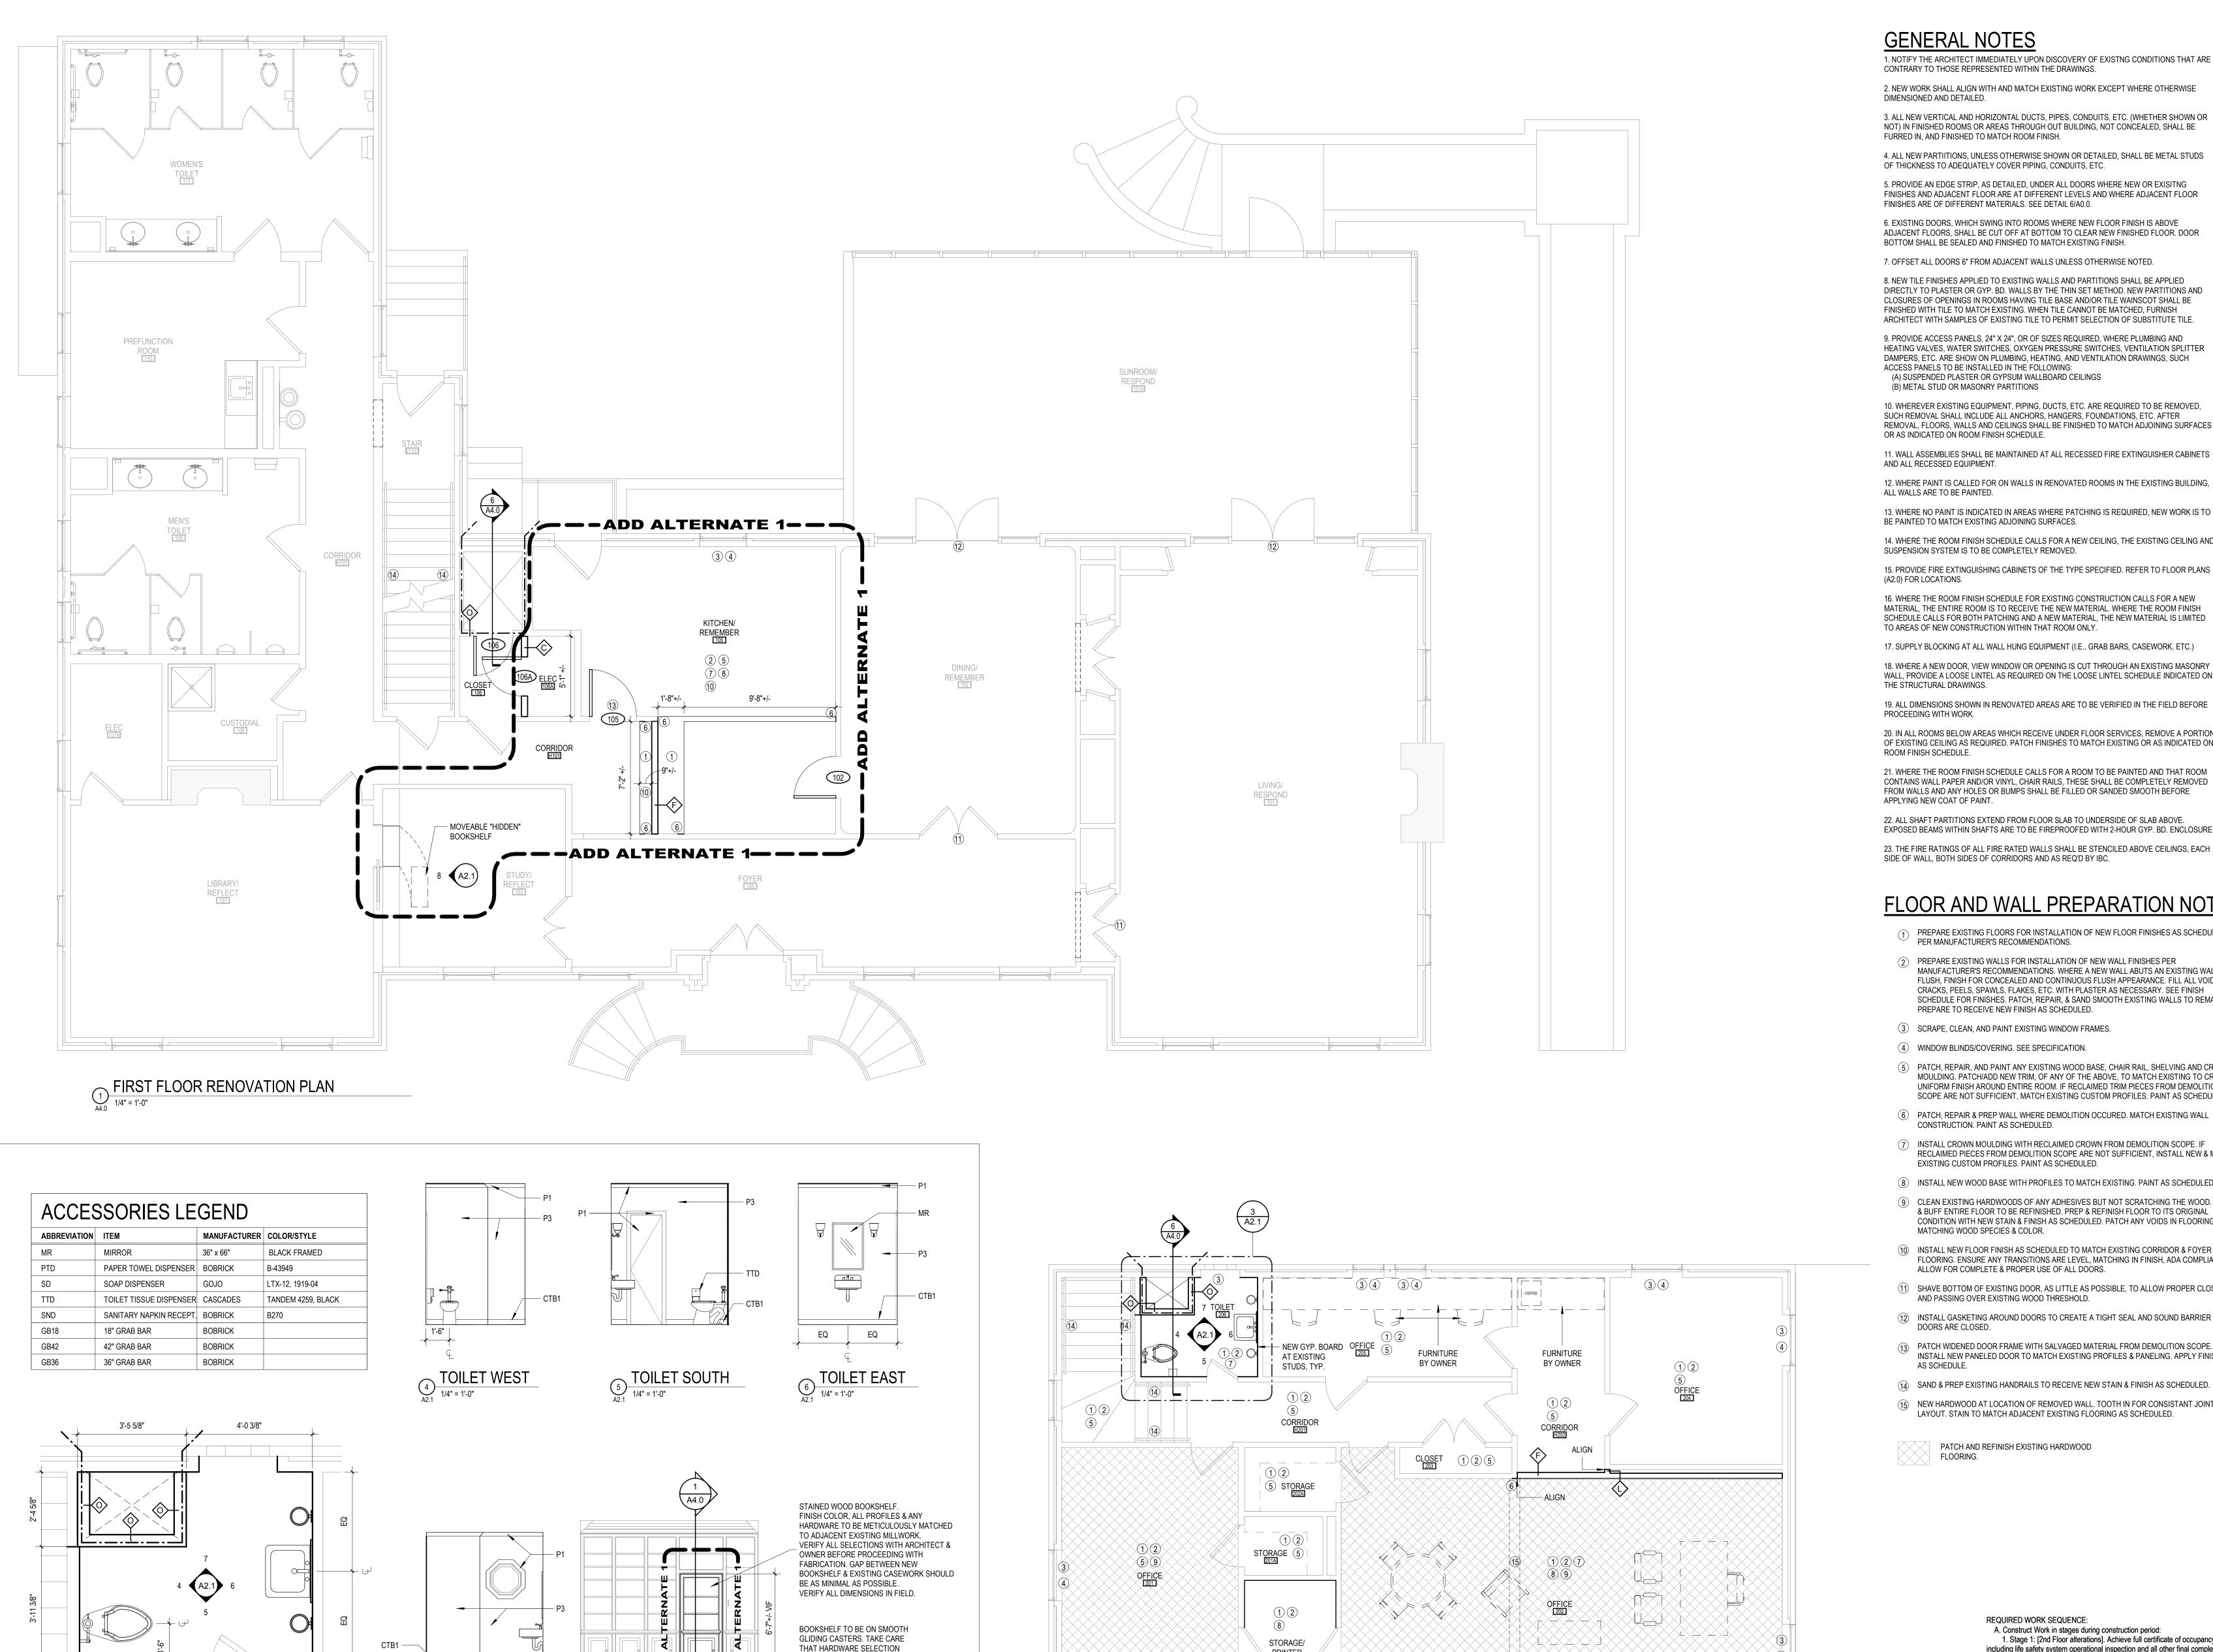
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FIRST & SECOND FLOOR DEMOLITION

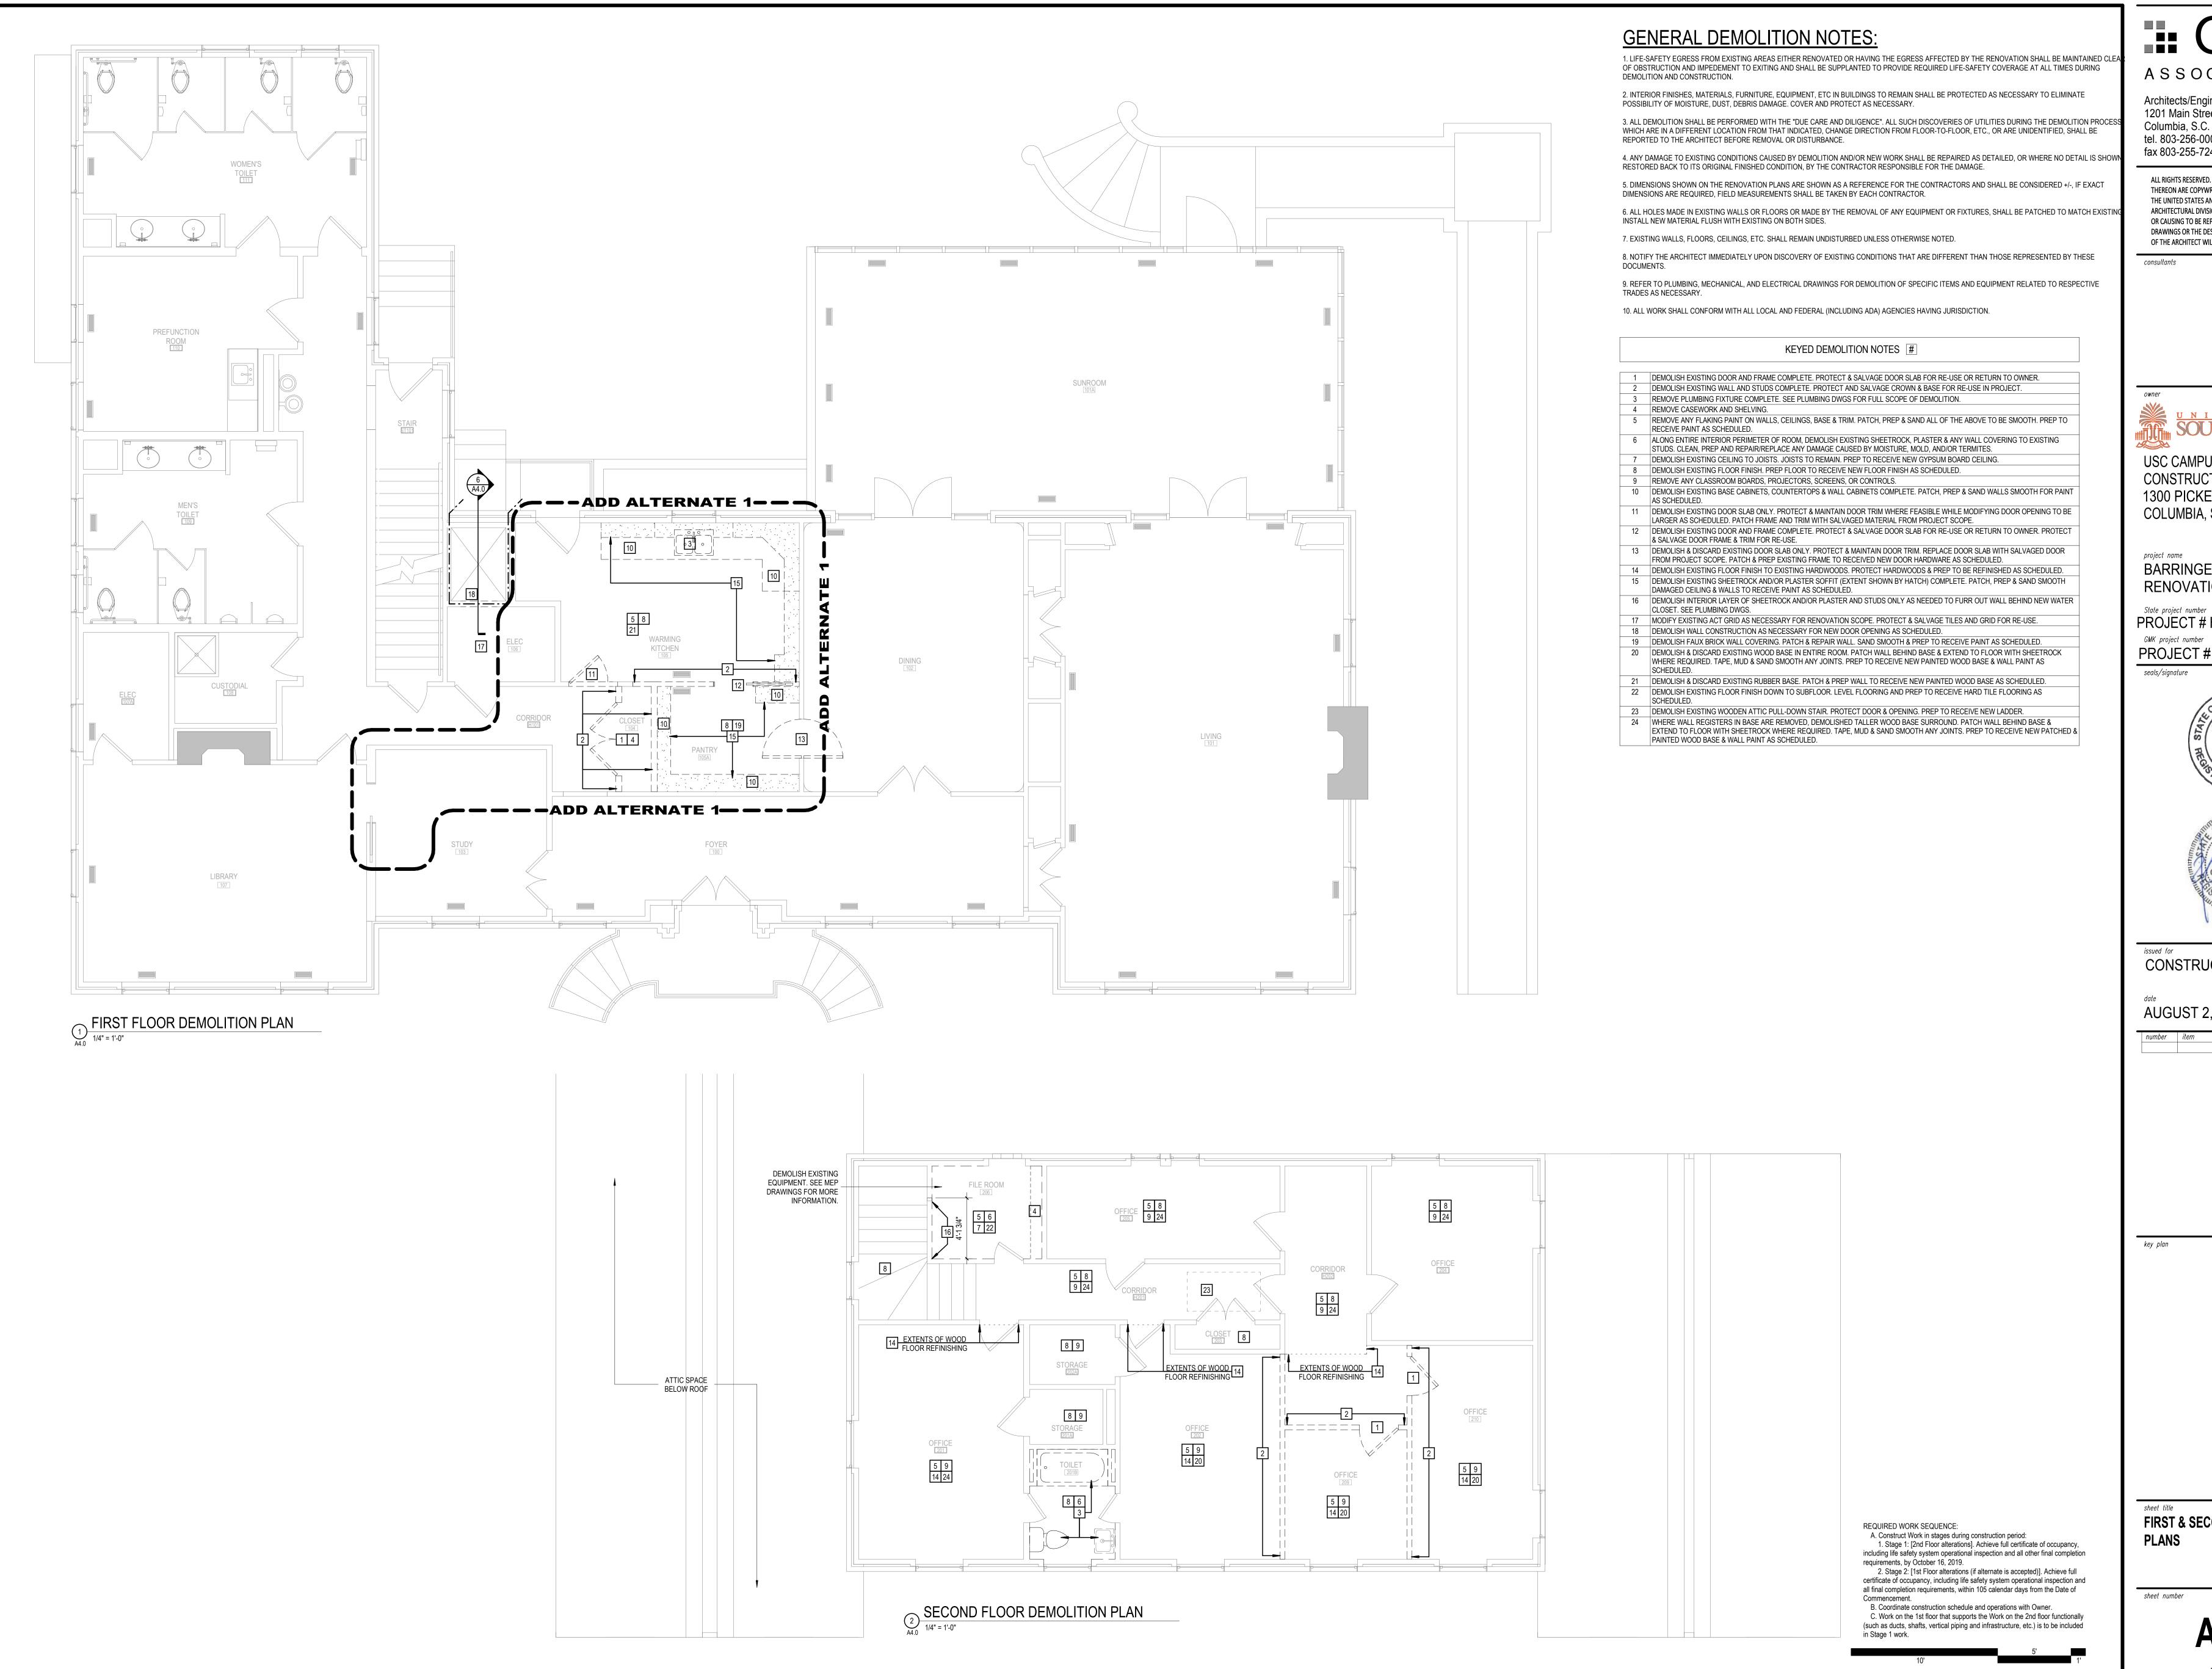sheet number

<u>checked by</u> TMW



WILL NOT DAMAGE EXISTING

HARDWOOD FLOORING WITH

SPECIFIC DESCRIPTION OF MILLWORK:

USED (ROLLED AWAY TO REVEAL A HIDDEN

PASSAGE) IN PRESENTATIONS HELD AT THE FUTURE ANNE FRANK MUSEUM. ITS INTENT IS TO APPEAR "HIDDEN" AND BLEND IN SEAMLESSLY WITH THE EXISTING MILLWORK.

THIS BOOKSHELF IS A THEATRICAL PROP TO BE

FREQUENT MOVEMENT.

STUDY/REFLECT BOOKSHELF

8
1/4" = 1'-0"

ENLARGED PLAN - SECOND FLOOR TOILET

PRINTER 201B

SECOND FLOOR RENOVATION PLAN

1/4" = 1'-0"

- NEW GYP, BOARD AT

EXÎŞTÎNĞ ŞÎUDŞ, TYP.

GENERAL NOTES

1. NOTIFY THE ARCHITECT IMMEDIATELY UPON DISCOVERY OF EXISTNG CONDITIONS THAT ARE CONTRARY TO THOSE REPRESENTED WITHIN THE DRAWINGS.

2. NEW WORK SHALL ALIGN WITH AND MATCH EXISTING WORK EXCEPT WHERE OTHERWISE DIMENSIONED AND DETAILED.

3. ALL NEW VERTICAL AND HORIZONTAL DUCTS, PIPES, CONDUITS, ETC. (WHETHER SHOWN OR

4. ALL NEW PARTIITIONS, UNLESS OTHERWISE SHOWN OR DETAILED, SHALL BE METAL STUDS

OF THICKNESS TO ADEQUATELY COVER PIPING, CONDUITS, ETC. 5. PROVIDE AN EDGE STRIP, AS DETAILED, UNDER ALL DOORS WHERE NEW OR EXISITNG

FINISHES AND ADJACENT FLOOR ARE AT DIFFERENT LEVELS AND WHERE ADJACENT FLOOR FINISHES ARE OF DIFFERENT MATERIALS. SEE DETAIL 6/A0.0.

6. EXISTING DOORS, WHICH SWING INTO ROOMS WHERE NEW FLOOR FINISH IS ABOVE ADJACENT FLOORS, SHALL BE CUT OFF AT BOTTOM TO CLEAR NEW FINISHED FLOOR. DOOR BOTTOM SHALL BE SEALED AND FINISHED TO MATCH EXISTING FINISH.

7. OFFSET ALL DOORS 6" FROM ADJACENT WALLS UNLESS OTHERWISE NOTED.

8. NEW TILE FINISHES APPLIED TO EXISTING WALLS AND PARTITIONS SHALL BE APPLIED DIRECTLY TO PLASTER OR GYP. BD. WALLS BY THE THIN SET METHOD. NEW PARTITIONS AND CLOSURES OF OPENINGS IN ROOMS HAVING TILE BASE AND/OR TILE WAINSCOT SHALL BE FINISHED WITH TILE TO MATCH EXISTING. WHEN TILE CANNOT BE MATCHED, FURNISH ARCHITECT WITH SAMPLES OF EXISTING TILE TO PERMIT SELECTION OF SUBSTITUTE TILE.

9. PROVIDE ACCESS PANELS, 24" X 24", OR OF SIZES REQUIRED, WHERE PLUMBING AND HEATING VALVES, WATER SWITCHES, OXYGEN PRESSURE SWITCHES, VENTILATION SPLITTER DAMPERS, ETC. ARE SHOW ON PLUMBING, HEATING, AND VENTILATION DRAWINGS, SUCH ACCESS PANELS TO BE INSTALLED IN THE FOLLOWING: (A) SUSPENDED PLASTER OR GYPSUM WALLBOARD CEILINGS (B) METAL STUD OR MASONRY PARTITIONS

10. WHEREVER EXISTING EQUIPMENT, PIPING, DUCTS, ETC. ARE REQUIRED TO BE REMOVED, SUCH REMOVAL SHALL INCLUDE ALL ANCHORS, HANGERS, FOUNDATIONS, ETC. AFTER REMOVAL, FLOORS, WALLS AND CEILINGS SHALL BE FINISHED TO MATCH ADJOINING SURFACES OR AS INDICATED ON ROOM FINISH SCHEDULE.

11. WALL ASSEMBLIES SHALL BE MAINTAINED AT ALL RECESSED FIRE EXTINGUISHER CABINETS AND ALL RECESSED EQUIPMENT.

ALL WALLS ARE TO BE PAINTED. 13. WHERE NO PAINT IS INDICATED IN AREAS WHERE PATCHING IS REQUIRED, NEW WORK IS TO

BE PAINTED TO MATCH EXISTING ADJOINING SURFACES.

14. WHERE THE ROOM FINISH SCHEDULE CALLS FOR A NEW CEILING, THE EXISTING CEILING AND SUSPENSION SYSTEM IS TO BE COMPLETELY REMOVED.

15. PROVIDE FIRE EXTINGUISHING CABINETS OF THE TYPE SPECIFIED. REFER TO FLOOR PLANS (A2.0) FOR LOCATIONS.

16. WHERE THE ROOM FINISH SCHEDULE FOR EXISTING CONSTRUCTION CALLS FOR A NEW MATERIAL, THE ENTIRE ROOM IS TO RECEIVE THE NEW MATERIAL. WHERE THE ROOM FINISH SCHEDULE CALLS FOR BOTH PATCHING AND A NEW MATERIAL, THE NEW MATERIAL IS LIMITED TO AREAS OF NEW CONSTRUCTION WITHIN THAT ROOM ONLY.

17. SUPPLY BLOCKING AT ALL WALL HUNG EQUIPMENT (I.E., GRAB BARS, CASEWORK, ETC.)

18. WHERE A NEW DOOR. VIEW WINDOW OR OPENING IS CUT THROUGH AN EXISTING MASONRY WALL, PROVIDE A LOOSE LINTEL AS REQUIRED ON THE LOOSE LINTEL SCHEDULE INDICATED ON THE STRUCTURAL DRAWINGS.

19. ALL DIMENSIONS SHOWN IN RENOVATED AREAS ARE TO BE VERIFIED IN THE FIELD BEFORE PROCEEDING WITH WORK.

20. IN ALL ROOMS BELOW AREAS WHICH RECEIVE UNDER FLOOR SERVICES, REMOVE A PORTION OF EXISTING CEILING AS REQUIRED. PATCH FINISHES TO MATCH EXISTING OR AS INDICATED ON ROOM FINISH SCHEDULE.

21. WHERE THE ROOM FINISH SCHEDULE CALLS FOR A ROOM TO BE PAINTED AND THAT ROOM CONTAINS WALL PAPER AND/OR VINYL, CHAIR RAILS, THESE SHALL BE COMPLETELY REMOVED FROM WALLS AND ANY HOLES OR BUMPS SHALL BE FILLED OR SANDED SMOOTH BEFORE APPLYING NEW COAT OF PAINT.

22. ALL SHAFT PARTITIONS EXTEND FROM FLOOR SLAB TO UNDERSIDE OF SLAB ABOVE. EXPOSED BEAMS WITHIN SHAFTS ARE TO BE FIREPROOFED WITH 2-HOUR GYP. BD. ENCLOSURE. 23. THE FIRE RATINGS OF ALL FIRE RATED WALLS SHALL BE STENCILED ABOVE CEILINGS, EACH SIDE OF WALL, BOTH SIDES OF CORRIDORS AND AS REQ'D BY IBC.

FLOOR AND WALL PREPARATION NOTES

- PREPARE EXISTING FLOORS FOR INSTALLATION OF NEW FLOOR FINISHES AS SCHEDULED & PER MANUFACTURER'S RECOMMENDATIONS.
- PREPARE EXISTING WALLS FOR INSTALLATION OF NEW WALL FINISHES PER MANUFACTURER'S RECOMMENDATIONS. WHERE A NEW WALL ABUTS AN EXISTING WALL FLUSH, FINISH FOR CONCEALED AND CONTINUOUS FLUSH APPEARANCE. FILL ALL VOIDS, CRACKS, PEELS, SPAWLS, FLAKES, ETC. WITH PLASTER AS NECESSARY. SEE FINISH SCHEDULE FOR FINISHES. PATCH, REPAIR, & SAND SMOOTH EXISTING WALLS TO REMAIN. PREPARE TO RECEIVE NEW FINISH AS SCHEDULED.
- 3 SCRAPE, CLEAN, AND PAINT EXISTING WINDOW FRAMES.
- 4) WINDOW BLINDS/COVERING. SEE SPECIFICATION.
- PATCH, REPAIR, AND PAINT ANY EXISTING WOOD BASE, CHAIR RAIL, SHELVING AND CROWN MOULDING. PATCH/ADD NEW TRIM, OF ANY OF THE ABOVE, TO MATCH EXISTING TO CREATE UNIFORM FINISH AROUND ENTIRE ROOM. IF RECLAIMED TRIM PIECES FROM DEMOLITION SCOPE ARE NOT SUFFICIENT, MATCH EXISTING CUSTOM PROFILES. PAINT AS SCHEDULED.
- (6) PATCH, REPAIR & PREP WALL WHERE DEMOLITION OCCURED. MATCH EXISTING WALL CONSTRUCTION. PAINT AS SCHEDULED.
- INSTALL CROWN MOULDING WITH RECLAIMED CROWN FROM DEMOLITION SCOPE. IF RECLAIMED PIECES FROM DEMOLITION SCOPE ARE NOT SUFFICIENT, INSTALL NEW & MATCH EXISTING CUSTOM PROFILES. PAINT AS SCHEDULED.
- INSTALL NEW WOOD BASE WITH PROFILES TO MATCH EXISTING. PAINT AS SCHEDULED.
- CLEAN EXISTING HARDWOODS OF ANY ADHESIVES BUT NOT SCRATCHING THE WOOD. SAND & BUFF ENTIRE FLOOR TO BE REFINISHED. PREP & REFINISH FLOOR TO ITS ORIGINAL CONDITION WITH NEW STAIN & FINISH AS SCHEDULED. PATCH ANY VOIDS IN FLOORING WITH MATCHING WOOD SPECIES & COLOR.
- INSTALL NEW FLOOR FINISH AS SCHEDULED TO MATCH EXISTING CORRIDOR & FOYER FLOORING. ENSURE ANY TRANSITIONS ARE LEVEL, MATCHING IN FINISH, ADA COMPLIANT & ALLOW FOR COMPLETE & PROPER USE OF ALL DOORS.
- (1) SHAVE BOTTOM OF EXISTING DOOR, AS LITTLE AS POSSIBLE, TO ALLOW PROPER CLOSURE AND PASSING OVER EXISTING WOOD THRESHOLD.
- (12) INSTALL GASKETING AROUND DOORS TO CREATE A TIGHT SEAL AND SOUND BARRIER WHEN DOORS ARE CLOSED.
- PATCH WIDENED DOOR FRAME WITH SALVAGED MATERIAL FROM DEMOLITION SCOPE. INSTALL NEW PANELED DOOR TO MATCH EXISTING PROFILES & PANELING. APPLY FINISHES
- (14) SAND & PREP EXISTING HANDRAILS TO RECEIVE NEW STAIN & FINISH AS SCHEDULED.
- (15) NEW HARDWOOD AT LOCATION OF REMOVED WALL. TOOTH IN FOR CONSISTANT JOINT LAYOUT. STAIN TO MATCH ADJACENT EXISTING FLOORING AS SCHEDULED.
- PATCH AND REFINISH EXISTING HARDWOOD FLOORING.

in Stage 1 work.

REQUIRED WORK SEQUENCE: A. Construct Work in stages during construction period: 1. Stage 1: [2nd Floor alterations]. Achieve full certificate of occupancy, including life safety system operational inspection and all other final completion requirements, by October 16, 2019. 2. Stage 2: [1st Floor alterations (if alternate is accepted)]. Achieve full certificate of occupancy, including life safety system operational inspection and all final completion requirements, within 105 calendar days from the Date of

Commencement. B. Coordinate construction schedule and operations with Owner. C. Work on the 1st floor that supports the Work on the 2nd floor functionally (such as ducts, shafts, vertical piping and infrastructure, etc.) is to be included

<u>checked by</u> TMW

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BARRINGER HOUSE **RENOVATIONS**


State project number PROJECT # H27-D339-ID GMK project number

PROJECT # 16070.03/H27-D339-ID seals/signature

DIVISION, INC.

Columbia, SC

No. B74015

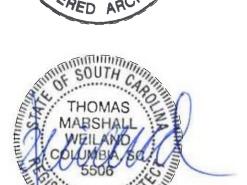

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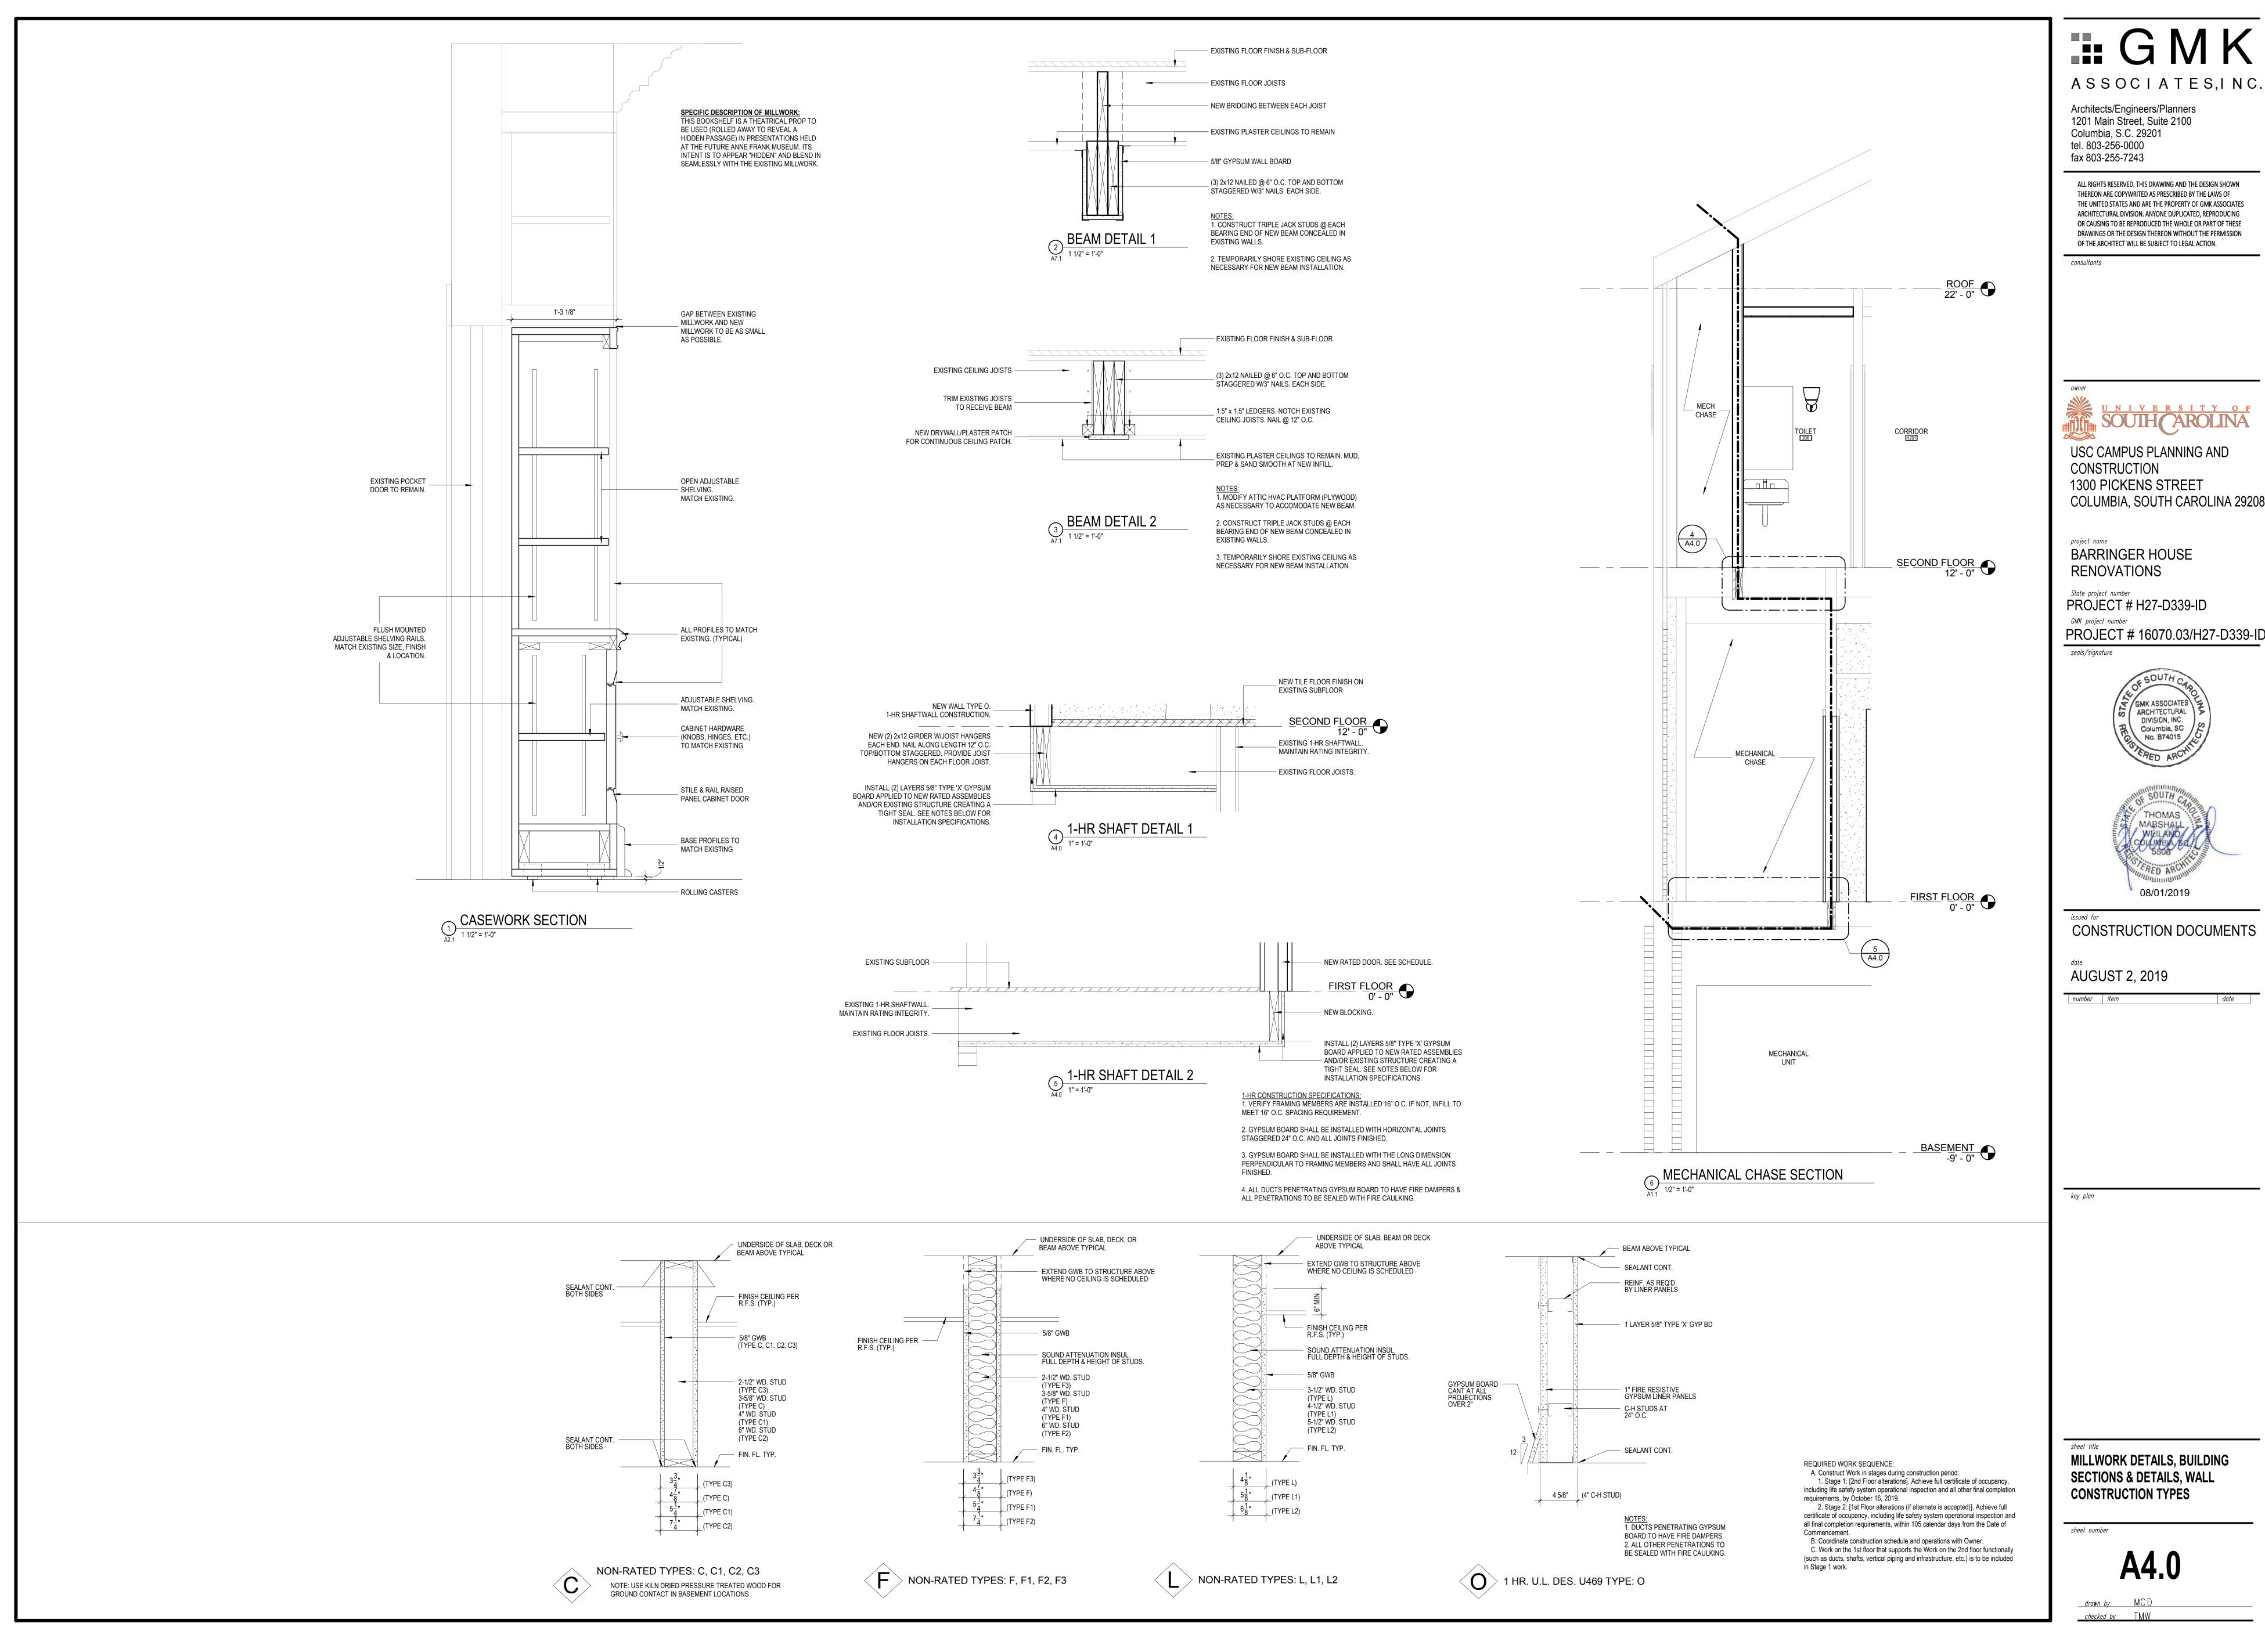
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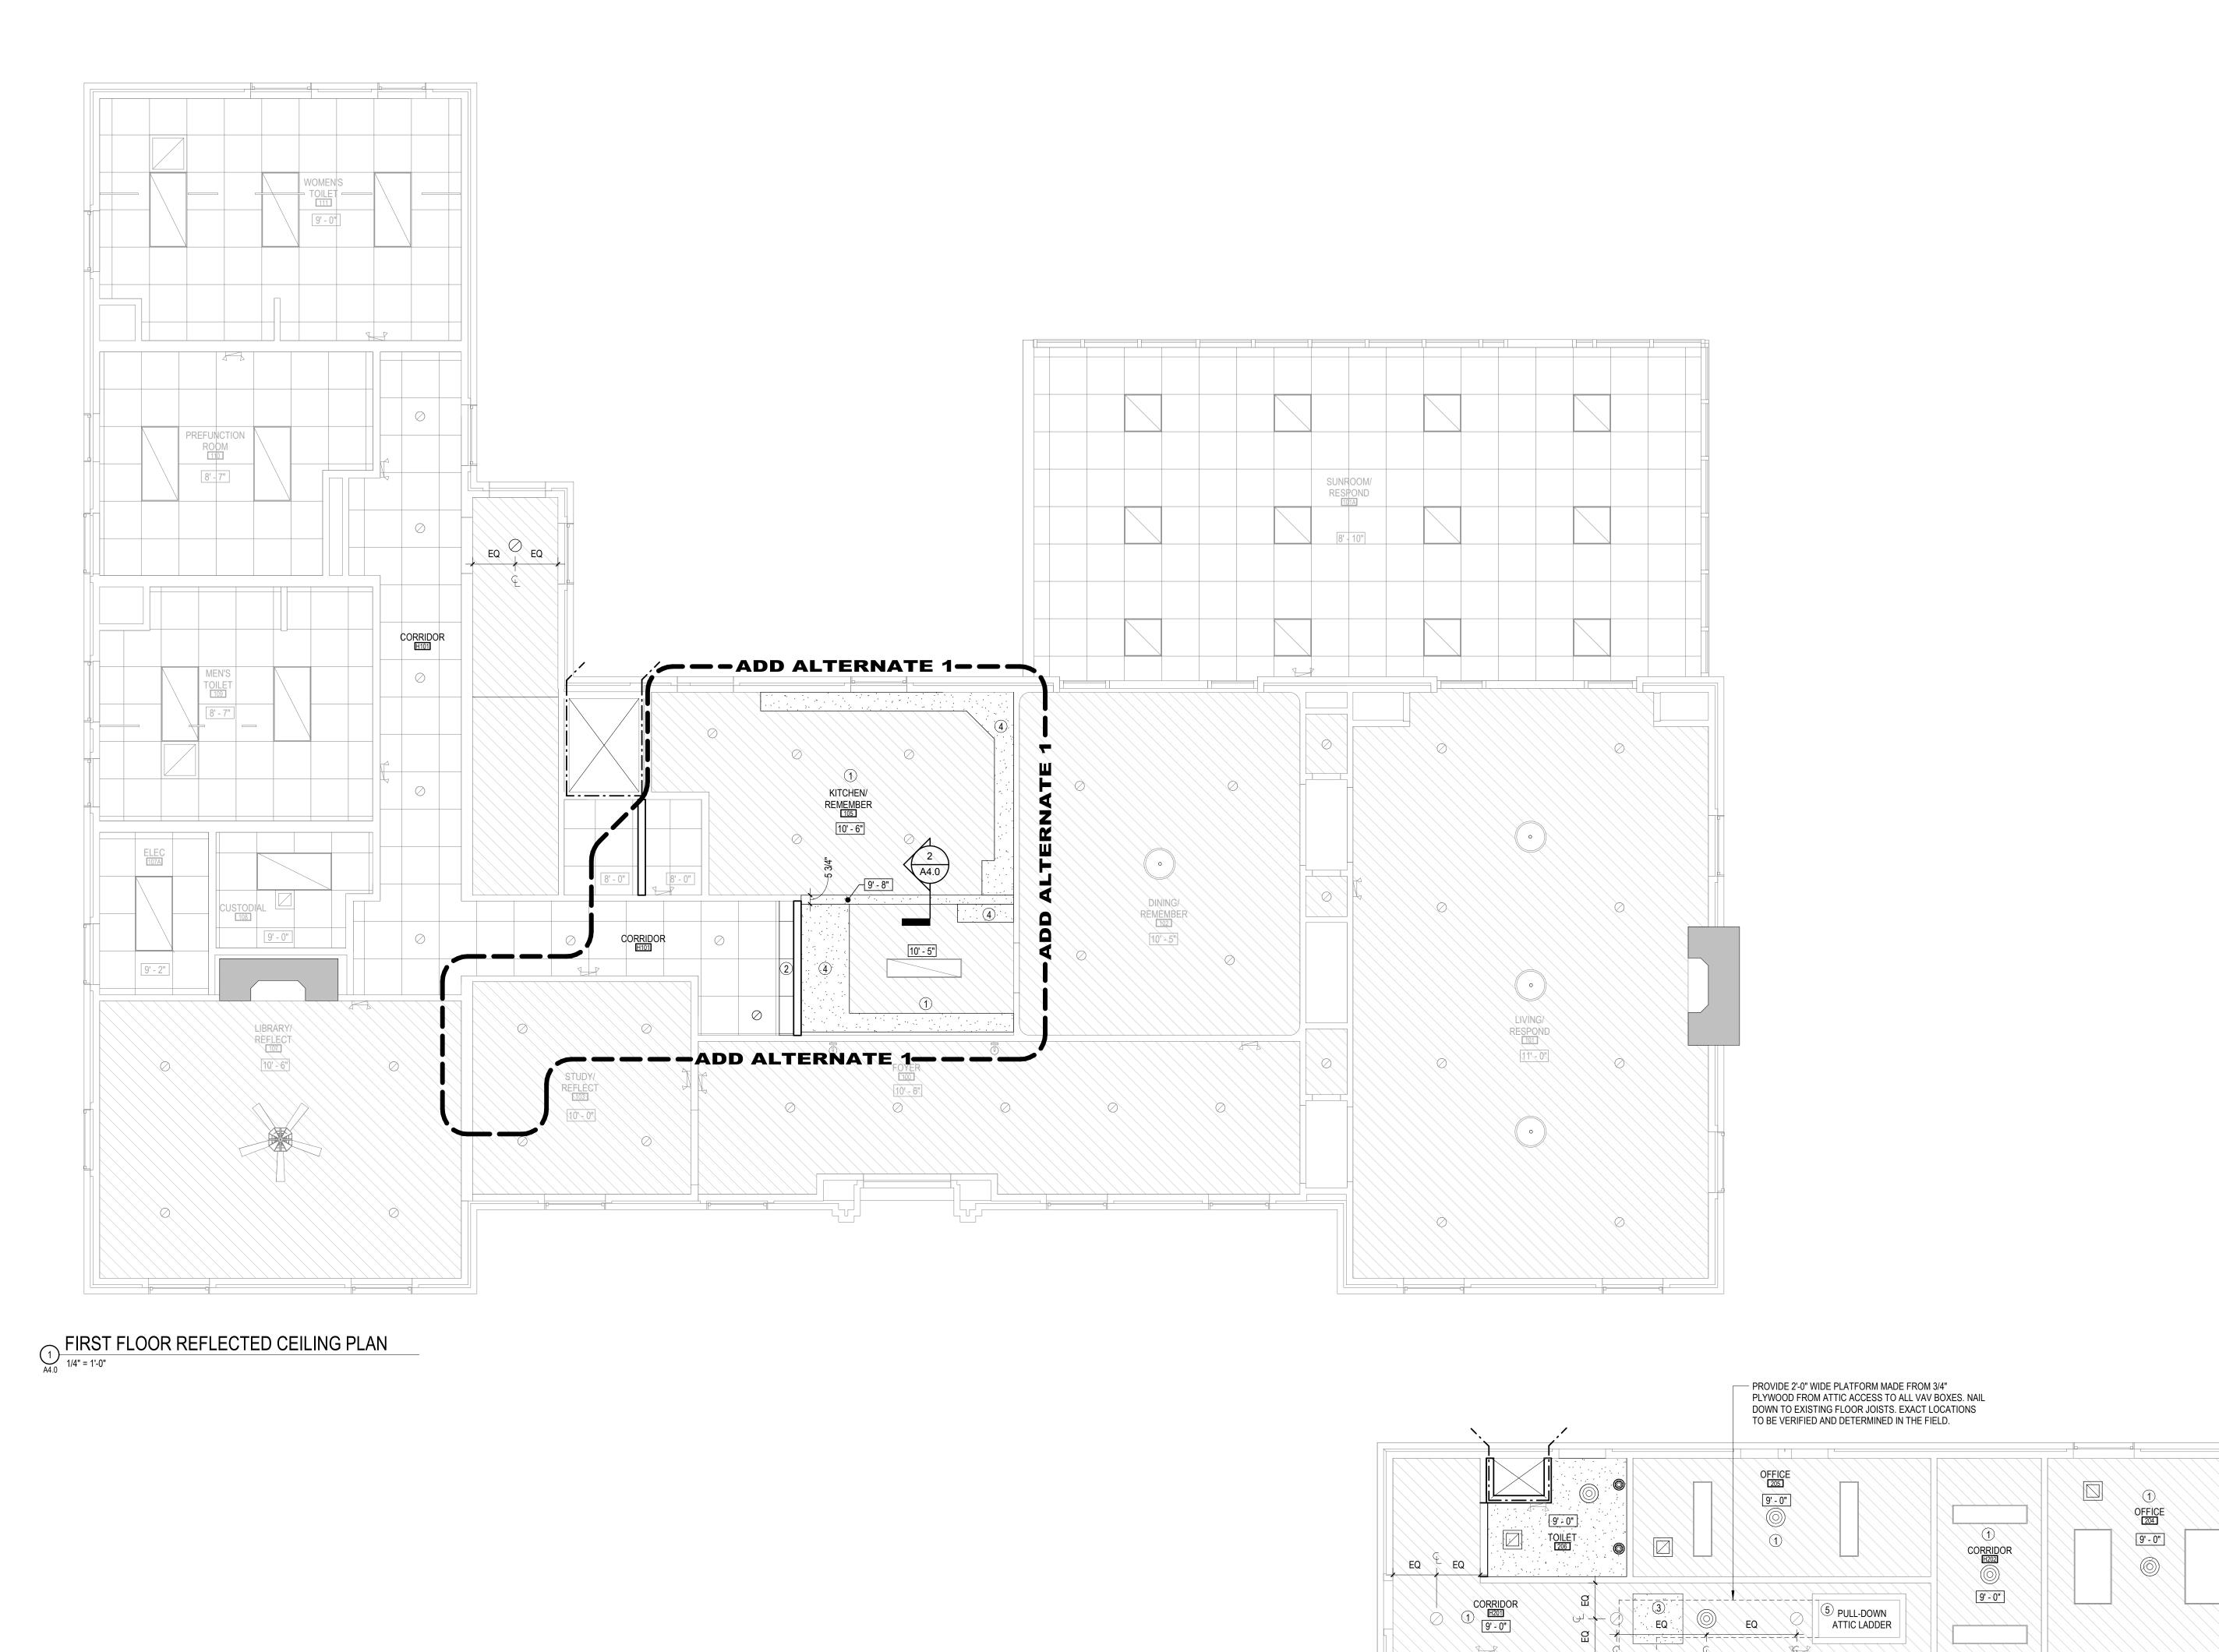
key plan

FIRST & SECOND FLOOR RENOVATION PLANS, ENLARGED PLANS & INTERIOR **ELEVATIONS**

sheet number



COLUMBIA, SOUTH CAROLINA 29208



SYMBOL LEGEND

9'-0" CEILING HEIGHT AFF

OTS OPEN TO STRUCTURE

ACCOUSTIC TILE

NEW GYPSUM BOARD C

NEW GYPSUM BOARD CEILING
OR NEW CEILING PATCH.
EXISTING GYPSUM BOARD CEILING.
PATCH, REPAIR, PREPARE & PAINT.
SURFACE MOUNTED LIGHT FIXTURE

RECESSED LIGHT FIXTURE

LED STRIP LIGHT

PENDANT LIGHT FIXTURE

HVAC DIFFUSER/GRILLE

HVAC DIFFUSER/GRILLE

HVAC DIFFUSER/GRIL
CEILING FAN

CEILING NOTES

- (1) CEILING TO BE MINIMALLY DAMAGED BY ELECTRICAL AND MECHANICAL WORK. PATCH, REPAIR AND PAINT CEILINGS TO REMAIN TO MATCH EXISTING.
- ② EXTEND ACT GRID TO BE CONTINUOUS. MATCH EXISTING GRID & TILE AS SPECIFIED.
- 3 PATCH CEILING WHERE EXISTING HVAC DEVICES WERE DEMOLISHED. SAND TO BE SMOOTH, FLUSH AND CONTINUOUS TO EXISTING CEILING.
- 4 PATCH CEILING WHERE EXISTING BULKHEAD AND/OR WALL WAS DEMOLISHED. SAND TO BE SMOOTH, FLUSH AND CONTINUOUS TO EXISTING CEILING.
- (5) INSTALL NEW ALUMINUM PULL-DOWN ATTIC LADDER. MATCH EXISTING SIZE.

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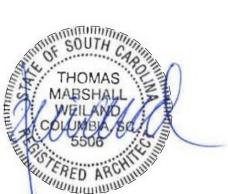
project name
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seals/signature

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ARCHITECTURAL
DIVISION, INC.
Columbia, SC
No. B74015



issued for CONSTRUCTION DOCUMENTS

AUGUST 2, 2019

number litera

heet title

FIRST AND SECOND FLOORS

REFLECTED CEILING PLAN

sheet number

A7.1

drawn by MCD

SECOND FLOOR REFLECTED CEILING PLAN

3
1/4" = 1'-0"

EQ5

CONCEALED BEAM ABOVE CEILING.

EQ6

2 3'-0" 2'-7 5/8" 2'-7 5/8" 3'-0"

OFFICE 2011 9' - 0" STORAGE/ PRINTER 2018

REQUIRED WORK SEQUENCE:

A. Construct Work in stages during construction period:


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all final completion requirements, within 105 calendar days from the Date of Commencement.

B. Coordinate construction schedule and operations with Owner.

C. Work on the 1st floor that supports the Work on the 2nd floor functionally (such as ducts, shafts, vertical piping and infrastructure, etc.) is to be included in Stage 1 work.



				FIN	NSH SCHE	DULI	
		FLOOR	ROOM TRIM/		WALLS	CEILING	
ROOM NUMBER	ROOM NAME	FINISH	FLOOR BASE	FINISH	ACCENT	FINISH	REMARKS
						•	
BASEMENT							
001	STAGING	EXIST	EXIST	EXIST		EXIST	
002	JAN	EXIST	EXIST	EXIST		EXIST	
003	MECHANICAL/ELECTRICAL	EXIST	EXIST	EXIST		EXIST	
004	MECHANICAL	EXIST	EXIST	EXIST		EXIST	
H001	CORRIDOR	EXIST	EXIST	EXIST		EXIST	
FIRST FLOOR							
100	FOYER	EXIST	EXIST	EXIST		EXIST	
101	LIVING/ RESPOND	EXIST	EXIST - P4	EXIST		EXIST	
101A	SUNROOM/ RESPOND	EXIST	EXIST	EXIST		EXIST	
102	DINING/ REMEMBER	EXIST	EXIST - P4	P5	P4 AT WAINSCOT	EXIST	
103	STUDY/ REFLECT	EXIST	EXIST	EXIST		EXIST	DD ALTERNATE 1
105	KITCHEN/ REMEMBER	WD2	WDB1* - P1	P1	P1 AT CROWN	P1	*USE SALVAGED BASE & CROWN FROM DEMOLITION SCOPE.
106	CLOSET	EXIST	RB1	P1		ACT1	
106A	ELEC	EXIST	RB1	P1		ACT1	
107	LIBRARY/ REFLECT	EXIST	EXIST	EXIST		EXIST	
107A	ELEC	EXIST	EXIST	EXIST		EXIST	
108	CUSTODIAL	EXIST	EXIST	EXIST		EXIST	
109	MEN'S TOILET	EXIST	EXIST	EXIST		EXIST	
110	PREFUNCTION ROOM	EXIST	EXIST	EXIST		EXIST	
111	WOMEN'S TOILET	EXIST	EXIST	EXIST		EXIST	
H101	CORRIDOR	EXIST	EXIST	P2		ACT1	DD ALTERNATE 1—————
ST101	STAIR	CPT1	EXIST - P1	P2	STAIN AT HANDRAILS*	P1	*HANDRAIL STAIN TO MATCH REFINISHED HARDWOODS. COLOR BY ARCHITECT/OWNER
SECOND FLOOR							
201	OFFICE	CPT1	EXIST - P1	P2		P1	
201A	STORAGE	CPT1	EXIST - P1	P2		P1	
201B	STORAGE/ PRINTER	CPT1	RB1	P2		P1	
202	OFFICE	WD1	WDB1* - P1	P2	P1 AT CROWN	P1	*USE SALVAGED BASE & CROWN FROM DEMOLITION SCOPE.
202A	STORAGE	CPT1	EXIST - P1	P2		P1	
203	CLOSET	CPT1	EXIST - P1	P2		P1	
204	OFFICE	CPT1	EXIST - P1	P2		P1	
205	OFFICE	CPT1	EXIST - P1	P2		P1	
206	TOILET	CT1	CTB1	P3	P1 AT CROWN	P1	*USE SALVAGED CROWN FROM DEMOLITION SCOPE.
H201	CORRIDOR	CPT1	EXIST - P1	P1		P1	
H202	CORRIDOR	CPT1	EXIST - P1	P1		P1	

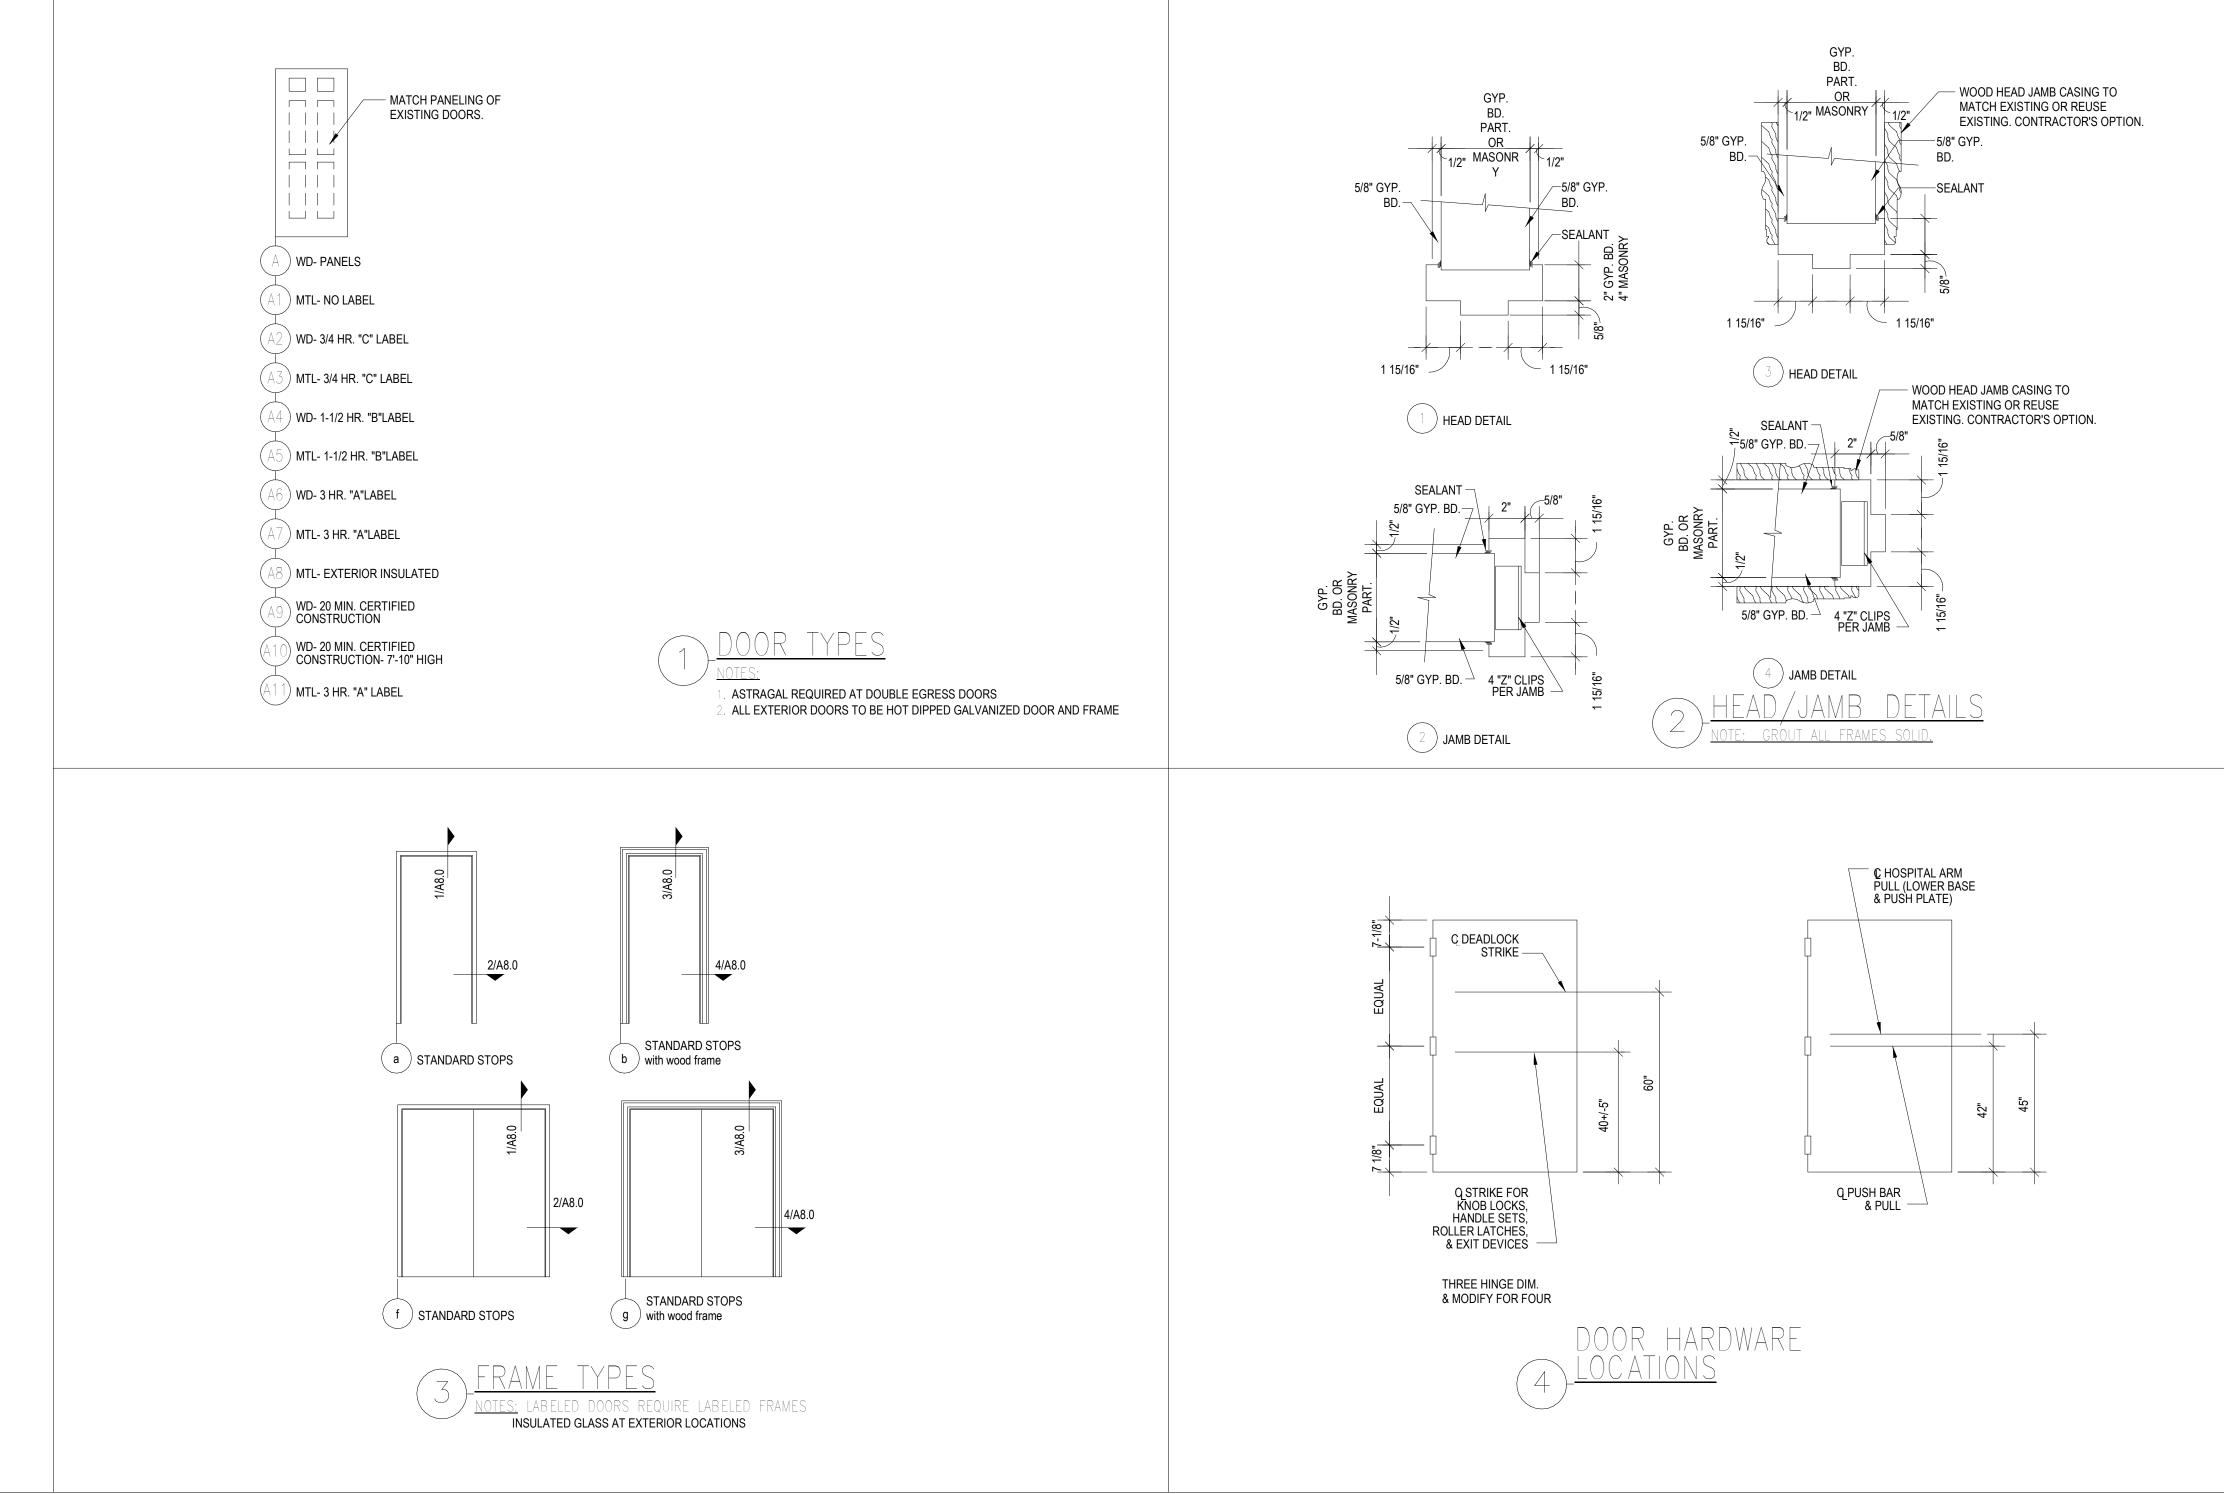ACT1 ACOUSTICAL CEILING TILE ARMSTRONG ULTIMA BEVELED TEGULAR MATCH EXISTING SUPRAFINE XL FIREGUARD 9/16" EXPOSED TEE FLOORING CPT1 CARPET 1 MANNINGTON MOSSO, BROOM 42332 BROADLOOM VCT1 VINYL COMPOSITION TILE 1 JOHNSONITE AZROCK VCT, V-217 WEATHERED CB 12" x 12" WD1 WOOD FLOOR 1" OAK EXISTING "REFINISHED EXISTING HARDWOODS, SEE NOTE 2 BELOW WD2 WOOD FLOOR 2 OAK MATCH EXISTING SEE SPECS CT1 CERAMIC FLOOR TILE ROCA CC MOSAICS, HEXAGON WHITE & BLACK MATTE 1" x 1" PAINT P1 TRIM PAINT SHERWIN WILLIAMS SW 7006 EXTRA WHITE (BRIGHT WHITE) WALL: CASHMERE PEARL SHEEN, TRIM/BASE: SEMI-GLOSS P2 FIELD PAINT SHERWIN WILLIAMS SW 6169 SEDATE GRAY CASHMERE PEARL SHEEN P3 FIELD PAINT SHERWIN WILLIAMS SW 7004 SNOWBOUND CASHMERE PEARL SHEEN P4 FIELD PAINT SHERWIN WILLIAMS SW 6105 DIVINE WHITE (OFF-WHITE) P5 FIELD PAINT SHERWIN WILLIAMS SW 6105 DIVINE WHITE (OFF-WHITE) P6 FIELD PAINT SHERWIN WILLIAMS SW 6105 DIVINE WHITE (OFF-WHITE) P6 FIELD PAINT SHERWIN WILLIAMS SW 6105 DIVINE WHITE (OFF-WHITE) P6 FIELD PAINT SHERWIN WILLIAMS SW 6105 DIVINE WHITE (OFF-WHITE) P6 FIELD PAINT SHERWIN WILLIAMS SW 6105 DIVINE WHITE (OFF-WHITE) P6 FIELD PAINT SHERWIN WILLIAMS SW 6105 DIVINE WHITE (OFF-WHITE) P6 FIELD PAINT SHERWIN WILLIAMS SW 6105 DIVINE WHITE (OFF-WHITE) P6 FIELD PAINT SHERWIN WILLIAMS SW 6105 DIVINE WHITE (OFF-WHITE) P6 FIELD PAINT SHERWIN WILLIAMS SW 6105 DIVINE WHITE (OFF-WHITE) P6 FIELD PAINT SHERWIN WILLIAMS SW 6105 DIVINE WHITE (OFF-WHITE) P7 SECLAIMED BASE FROM DEMOLITION SCOPE, SEMI-GLOSS PAINT WD81 WOOD WALL BASE* SW 7006 EXTRA WHITE (BRIGHT WHITE) WD81 WOOD WALL BASE FROM DEMOLITION SCOPE, SEMI-GLOSS PAINT	ABBREVIATION	MATERIAL	MANUFACTURER	COLOR/STYLE	SIZE	NOTES
FLOORING CPTI CARPET 1 MANNINGTON MOSSO, BROOM 42332 BROADLOOM VCTI VINYL COMPOSITION TILE 1 JOHNSONITE AZROCK VCT, V-217 WEATHERED CB 12° x 12° WD1 WOOD FLOOR 1° OAK EXISTING REFINISHED EXISTING HARDWOODS, SEE NOTE 2 BELOW WD2 WOOD FLOOR 2 OAK MATCH EXISTING SEE SPECS CT1 CERAMIC FLOOR TILE ROCA CC MOSAICS, HEXAGON WHITE & BLACK MATTE 1° x 1° PAINT TRIM PAINT SHERWIN WILLIAMS SW 7006 EXTRA WHITE (BRIGHT WHITE) P1 TRIM PAINT SHERWIN WILLIAMS SW 6169 SEDATE GRAY CASHMERE PEARL SHEEN, TRIMBASE: SEMI-GLOSS P2 FIELD PAINT SHERWIN WILLIAMS SW 7004 SNOWBOUND CASHMERE PEARL SHEEN P3 FIELD PAINT SHERWIN WILLIAMS SW 6169 DIVINE WHITE (OFF-WHITE) P4 FIELD PAINT SHERWIN WILLIAMS SW 6693 LILY (YELLOW) P5 FIELD PAINT SHERWIN WILLIAMS SW 6693 LILY (YELLOW) FLOOR BASE RB1 RUBBER WALL BASE JOHNSONITE 44 DARK BROWN WOOD WALL BASE* SEMI-GLOSS PAINT MATCH EXISTING RECLAIMED BASE FROM DEMOLITION SCOPE, SEMI-GLOSS PAINT	CEILING					
VCT1 VINYL COMPOSITION TILE 1 JOHNSONITE AZROCK VCT, V-217 WEATHERED CB 12" x 12" WD1 WOOD FLOOR 1* OAK EXISTING *REFINISHED EXISTING HARDWOODS, SEE NOTE 2 BELOW WD2 WOOD FLOOR 2 OAK MATCH EXISTING SEE SPECS CT1 CERAMIC FLOOR TILE ROCA CC MOSAICS, HEXAGON WHITE & BLACK MATTE 1" x 1" PAINT TIM PAINT SHERWIN WILLIAMS SW 7006 EXTRA WHITE (BRIGHT WHITE) WALL: CASHMERE PEARL SHEEN, TRIM/BASE: SEMI-GLOSS P2 FIELD PAINT SHERWIN WILLIAMS SW 6169 SEDATE GRAY CASHMERE PEARL SHEEN P3 FIELD PAINT SHERWIN WILLIAMS SW 7004 SNOWBOUND CASHMERE PEARL SHEEN P4 FIELD PAINT SHERWIN WILLIAMS SW 6693 LILY (YELLOW) CASHMERE PEARL SHEEN FLOOR BASE FLOOR BASE RB1 RUBBER WALL BASE JOHNSONITE 44 DARK BROWN 4" WD00 WALL BASE* SW 7006 EXTRA WHITE (BRIGHT WHITE) MATCH EXISTING *RECLAIMED BASE FROM DEMOLITION SCOPE, SEMI-GLOSS PAINT	ACT1	ACOUSTICAL CEILING TILE	ARMSTRONG	ULTIMA BEVELED TEGULAR	MATCH EXISTING	SUPRAFINE XL FIREGUARD 9/16" EXPOSED TEE
VCT1 VINYL COMPOSITION TILE 1 JOHNSONITE AZROCK VCT, V-217 WEATHERED CB 12" x 12" WD1 WOOD FLOOR 1* OAK EXISTING *REFINISHED EXISTING HARDWOODS, SEE NOTE 2 BELOW WD2 WOOD FLOOR 2 OAK MATCH EXISTING CERAMIC FLOOR TILE ROCA CC MOSAICS, HEXAGON WHITE & BLACK MATTE 1" x 1" PAINT IT IN PAINT SHERWIN WILLIAMS SW 7006 EXTRA WHITE (BRIGHT WHITE) P1 TRIM PAINT SHERWIN WILLIAMS SW 6169 SEDATE GRAY CASHMERE PEARL SHEEN, TRIM/BASE: SEMI-GLOSS P2 FIELD PAINT SHERWIN WILLIAMS SW 7004 SNOWBOUND CASHMERE PEARL SHEEN P3 FIELD PAINT SHERWIN WILLIAMS SW 6105 DIVINE WHITE (OFF-WHITE) P4 FIELD PAINT SHERWIN WILLIAMS SW 6693 LILY (YELLOW) P5 FIELD PAINT SHERWIN WILLIAMS SW 6693 LILY (YELLOW) FLOOR BASE RB1 RUBBER WALL BASE JOHNSONITE 44 DARK BROWN WATCH EXISTING *REFINISHED EXISTING HARDWOODS, SEE NOTE 2 BELOW MATCH EXISTING *REFINISHED EXISTING HARDWOODS, SEE NOTE 2 BELOW *REFINISHED EXISTING HARDWOODS *REFINISHED	FLOORING					
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PAINTImage: Company of the	WD2	WOOD FLOOR 2		OAK	MATCH EXISTING	SEE SPECS
P1 TRIM PAINT SHERWIN WILLIAMS SW 7006 EXTRA WHITE (BRIGHT WHITE) WALL: CASHMERE PEARL SHEEN, TRIM/BASE: SEMI-GLOSS P2 FIELD PAINT SHERWIN WILLIAMS SW 6169 SEDATE GRAY CASHMERE PEARL SHEEN P3 FIELD PAINT SHERWIN WILLIAMS SW 7004 SNOWBOUND CASHMERE PEARL SHEEN P4 FIELD PAINT SHERWIN WILLIAMS SW 6105 DIVINE WHITE (OFF-WHITE) SEMI-GLOSS P5 FIELD PAINT SHERWIN WILLIAMS SW 6693 LILY (YELLOW) CASHMERE PEARL SHEEN FLOOR BASE RB1 RUBBER WALL BASE JOHNSONITE 44 DARK BROWN 4" WDB1 WOOD WALL BASE* SW 7006 EXTRA WHITE (BRIGHT WHITE) MATCH EXISTING *RECLAIMED BASE FROM DEMOLITION SCOPE, SEMI-GLOSS PAINT	CT1	CERAMIC FLOOR TILE	ROCA	CC MOSAICS, HEXAGON WHITE & BLACK MATTE	1" x 1"	
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FLOOR BASE RB1 RUBBER WALL BASE JOHNSONITE 44 DARK BROWN WDB1 WOOD WALL BASE* SW 7006 EXTRA WHITE (BRIGHT WHITE) MATCH EXISTING *RECLAIMED BASE FROM DEMOLITION SCOPE, SEMI-GLOSS PAINT	P4	FIELD PAINT	SHERWIN WILLIAMS	SW 6105 DIVINE WHITE (OFF-WHITE)		SEMI-GLOSS
RB1 RUBBER WALL BASE JOHNSONITE 44 DARK BROWN 4" WDB1 WOOD WALL BASE* SW 7006 EXTRA WHITE (BRIGHT WHITE) MATCH EXISTING *RECLAIMED BASE FROM DEMOLITION SCOPE, SEMI-GLOSS PAINT	P5	FIELD PAINT	SHERWIN WILLIAMS	SW 6693 LILY (YELLOW)		CASHMERE PEARL SHEEN
WDB1 WOOD WALL BASE* SW 7006 EXTRA WHITE (BRIGHT WHITE) MATCH EXISTING *RECLAIMED BASE FROM DEMOLITION SCOPE, SEMI-GLOSS PAINT	FLOOR BASE					
(E-definition 2)	RB1	RUBBER WALL BASE	JOHNSONITE	44 DARK BROWN	4"	
CTB1 CERAMIC TILE BASE ROCA BLACK BRIGHT U759 A3401 3" x 6"	WDB1	WOOD WALL BASE*		SW 7006 EXTRA WHITE (BRIGHT WHITE)	MATCH EXISTING	*RECLAIMED BASE FROM DEMOLITION SCOPE, SEMI-GLOSS PAINT
	CTB1	CERAMIC TILE BASE	ROCA	BLACK BRIGHT U759 A3401	3" x 6"	

NOTES:
1. ALL WALLS SHOULD BE LEVEL 4 FINISH.
2. STAIN COLOR BY ARCHITECT/OWNER. CLEAR SATIN POLYURETHANE FINISH COAT.

ROOM NAME	DOOR NUMBER	DOOR ELEV	DOOR SIZE	FRAME ELEV	HDWR SET	REMARKS
FIRST FLOOR						DD ALTERNATE 1————
DINING/ REMEMBER	102	EXIST	32" x 84"	EXIST	1	*USE RECLAIMED DOOR FROM ROOM 105 OR 105A
(ITCHEN/ REMEMBER	105	EXIST	36" x 80"	MATCH EXIST	1	*PAINT CORRIDOR SIDE OF DOOR & FRAME P1. STAIN ROOM SIDE TO MATCH EXISTING
CLOSET	106	A3	30" x 80"	a	2	*PAINT DOOR & FRAME P1
ELEC	106A	A1	30" x 80"	а	2	*PAINT DOOR & FRAME P1

GENERAL DOOR NOTES:

1. ANY NEW DOORS/FRAMES OR MODIFIED DOORS/FRAMES SHALL HAVE TRIM PROFILES AND DOOR PANELING TO MATCH EXISTING.

2. DO NOT DISCARD OF ANY DEMOLISHED DOORS. PROTECT & SALVAGE FOR RE-USE OR RETURN TO OWNER.

HARDWARE SETS

SET NO. 1 -PASSAGE SET HINGES MORTISE LATCHSET SILENCERS

BUMPER

SET NO. 2 STORAGE SET
HINGES
MORTISE LOCKSET
SILENCERS
BUMPER

REQUIRED WORK SEQUENCE:

A. Construct Work in stages during construction period:

1. Stage 1: [2nd Floor alterations]. Achieve full certificate of occupancy, including life safety system operational inspection and all other final completion requirements, by October 16, 2019.

2. Stage 2: [1st Floor alterations (if alternate is accepted)]. Achieve full certificate of occupancy, including life safety system operational inspection and all final completion requirements, within 105 calendar days from the Date of

Commencement.

B. Coordinate construction schedule and operations with Owner.

C. Work on the 1st floor that supports the Work on the 2nd floor functionally (such as ducts, shafts, vertical piping and infrastructure, etc.) is to be included in Stage 1 work.

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USC CAMPUS PLANNING AND CONSTRUCTION 1300 PICKENS STREET COLUMBIA, SOUTH CAROLINA 29208


project name
BARRINGER HOUSE
RENOVATIONS

State project number
PROJECT # H27-D339-ID

GMK project number

PROJECT # 16070.03/H27-D339-ID



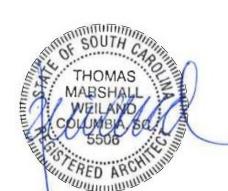

issued for CONSTRUCTION DOCUMENTS

AUGUST 2, 2019

number item a


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DOOR SCHEDULE, DOOR AND FRAME
TYPES, FINISH SCHEDULE & LEGEND

sheet number

A8.0

drawn by MAP

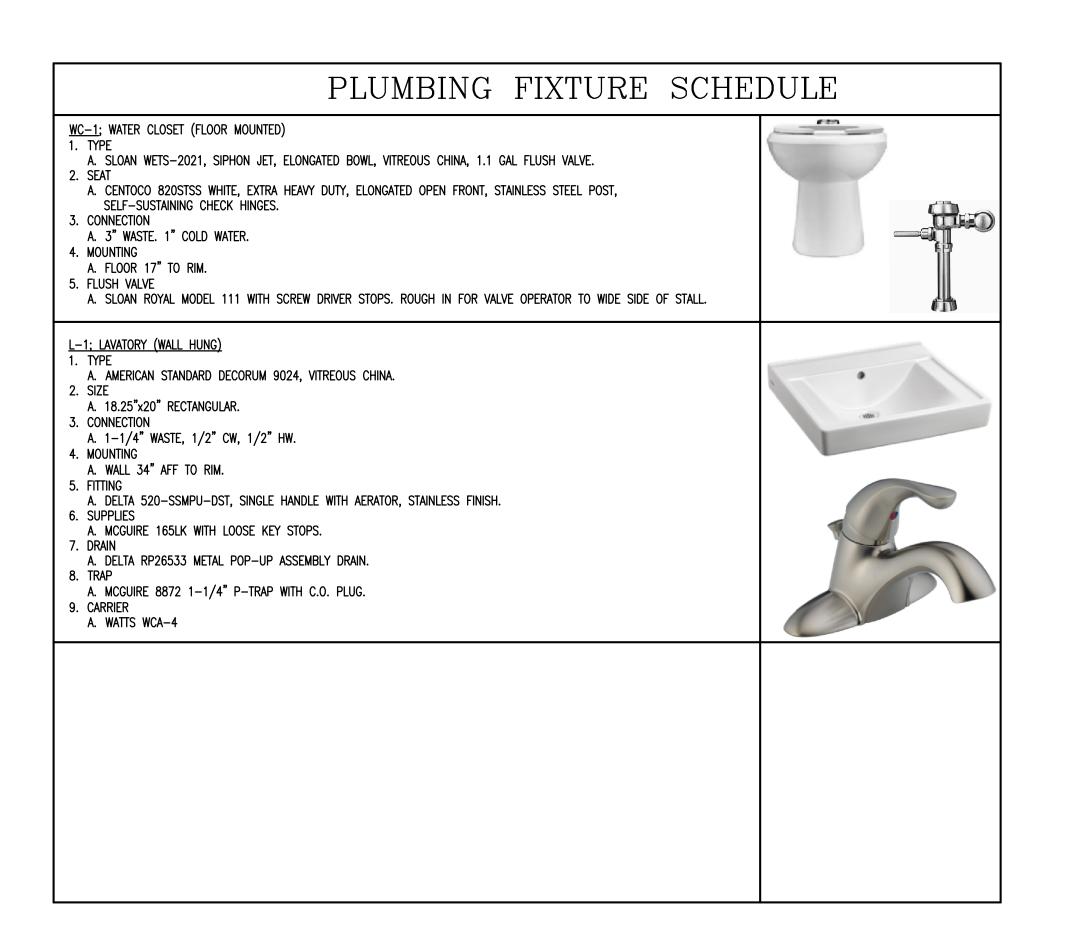


FIXT	FIXTURE SIZE SCHEDULE						
MARK	WASTE	VENT	CW	HW			
WC	3"	2"	1"				
LAV	1-1/4"	1-1/4"	1/2"	1/2"			
U	2"	1-1/2"	3/4"				
SK	1-1/2"	1-1/4"	1/2"	1/2"			
MSB	3"	1-1/2"	3/4"	3/4"			
EWC	EWC 1-1/4" 1-1/4" 1/2"						
NOTE: CONNECTION SIZE IS FOR SINGLE POINT CONNECTION. REFER TO PLANS FOR MULTIPLE OR HEADER TYPE CONNECTIONS. PLUMBING CONTRACTOR TO VERIFY WITH MANUFACTURER'S INSTRUCTIONS BEFORE FINAL CONNECTION.							

PIPE IDENT	TIFICATION SC	HEDULE
SERVICE TYPE	DECAL IDENTIFICATION	TAPE COLOR
COLD WATER SERVICE	COLD WATER SUPPLY	GREEN
HOT WATER	DOMESTIC HOT WATER	YELLOW
HOT WATER RETURN	HOT WATER RETURN	YELLOW

1. PIPE SIZES 1-1/4" TO 6", USE 2-1/4" LETTERING. 2. PIPE SIZES 1" OR LESS, USE 1-1/4" LETTERING.


WATER-HAMMER ARRESTER SCHEDULE									
PDI UNITS A B C D E F									
FIXTURE UNITS 1-11 12-32 33-60 61-113 114-154 155-330									
NOTES: FIXTURE UNITS BASED ON IPC. TABLE	OTES: FIXTURE UNITS BASED ON IPC. TABLE E103.3(2), LOAD VALUES ASSIGNED TO FIXTURES.								

NOTES: FIXTURE UNITS BASED ON IPC, TABLE ETUS.S(2), LUAD VALUES ASSIGNED TO FIXTURES.

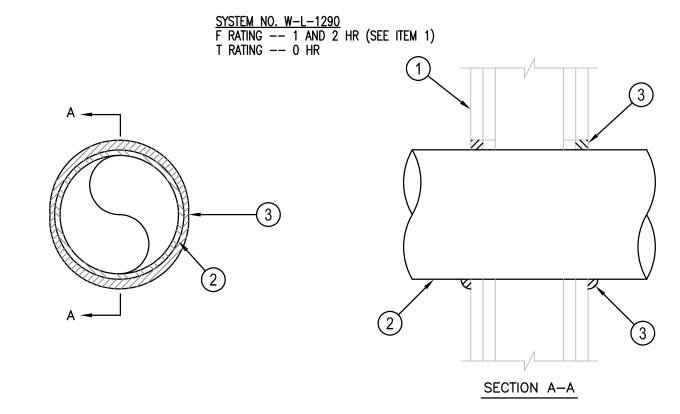

- 1. WALL ASSEMBLY -- THE 1 OR 2 HR FIRE RATED GYPSUM BOARD/STUD WALL ASSEMBLY SHALL INCLUDE THE FOLLOWING CONSTRUCTION FEATURES. A. STUDS -- REFER TO ARCH DETAILS FOR TYPE & CONSTRUCTION.
- B. GYPSUM BOARD*— —— REFER TO ARCH DETAILS FOR TYPE & CONSTRUCTION. MAX DIAM OF OPENING IS 5 IN. (THE HOURLY F & T RATINGS OF THE FIRESTOP SYSTEM ARE EQUAL TO THE HOURLY FIRE RATING OF THE WALL ASSEMBLY IN WHICH IT IS INSTALLED.)
- 2. THROUGH PENETRANT -- ONE METALLIC PIPE OR TUBING INSTALLED CONCENTRICALLY OR ECCENTRICALLY WITHIN THE FIRESTOP SYSTEM. PIPE, OR TUBING MAY BE INSTALLED AT AN ANGLE NOT GREATER THAN 45 DEGREES FROM PERPENDICULAR. PIPE OR TUBE TO BE RIGIDLY SUPPORTED ON BOTH SIDES OF WALL ASSEMBLY. THE ANNULAR SPACE BETWEEN THE PIPE OR TUBE & PERIPHERY OF THE OPENING SHALL BE MIN 0 IN (POINT CONTACT) TO MAX 1/2 IN. THE FOLLOWING TYPES & SIZES OF METALLIC PIPES MAY BE USED:
- A. IRON PIPE -- NOM 4 IN. DIAM (OR SMALLER) CAST OR DUCTILE IRON PIPE. B. COPPER PIPE -- SHALL FOLLOW WL-1243 SYSTEM
- 3. FILL, VOID OR CAVITY MATERIAL*—SEALANT —— MIN 5/8 IN. THICKNESS OF FILL MATERIAL APPLIED WITHIN THE ANNULUS, FLUSH WITH BOTH SURFACES OF WALL. AT THE POINT CONTACT LOCATION BETWEEN PIPE & WALL, A MIN 1/2 IN DIAM BEAD OF FILL MATERIAL SHALL BE APPLIED AT THE PIPE/WALL INTERFACE. *BEARING THE UL CLASSIFICATION MARK



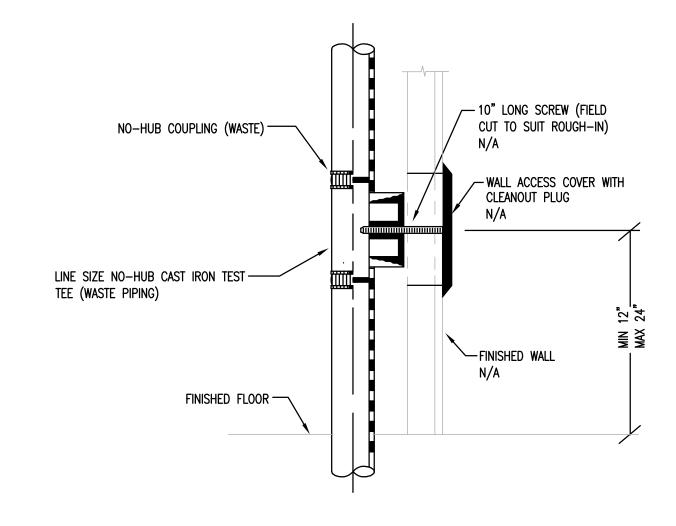

	PLUMBING LEGEND										
SYMBOL	DESCRIPTION		SYMBOL	DESCRIPTION							
	COLD WATER LINE - NEW (CW)			PIPE DOWN OR DROP (DN OR DROP)							
CW	COLD WATER LINE — EXISTING (CW)		0	PIPE UP							
	COLD WATER LINE — DEMO (CW)		<u></u>	PIPE BREAK OR CONTINUATION							
	HOT WATER LINE — NEW (HW)		—∞	P-TRAP							
——— HW ———	HOT WATER LINE — EXISTING (HW)			END CAP							
	HOT WATER LINE — DEMO (HW)		—— ——	UNION							
	HOT WATER RECIRCULATING LINE — NEW (HWR)		co —	INLINE CLEANOUT							
	SANITARY WASTE LINE — NEW (W)		SA-A	SHOCK ABSORBER & TYPE							
SAN	SANITARY WASTE LINE — EXISTING (W)		<u> </u>	BALL VALVE							
SAN	SANITARY WASTE LINE — DEMO (W)		+	POINT OF CONNECTION — NEW TO EXISTING							
	SANITARY VENT LINE — NEW (V)		//////	AREA TO BE DEMOLISHED							
	SANITARY VENT LINE — EXISTING (V)										
	SANITARY VENT LINE — DEMO (V)										

PLUMBING GENERAL NOTES

- VERIFY EXACT LOCATION OF ALL PLUMBING FIXTURES IN OR ATTACHED TO CASEWORK WITH THE ARCHITECT AND THE MILLWORK SHOP DRAWINGS. COORDINATE PRIOR TO INSTALLATION.
- CONFIRM OR VERIFY EXACT LOCATION AND ACTUAL INVERT OF SANITARY LINES PRIOR TO INSTALLATION.
- DUE TO THE LARGE QUANTITY OF PIPING, DUCTWORK, CONDUIT, ETC. OVERHEAD, COORDINATION WITH OTHER DISCIPLINES IS
- LOCATE SHUT-OFF VALVES ABOVE CEILINGS AND IN LOCATIONS ACCESSIBLE FOR SERVICE. LOCATION SHALL COMPLY WITH THE
- REQUIREMENTS OF ALL CODES REFERENCED HEREIN. PROVIDE CEILING MARKERS FOR LOCATION IDENTIFICATION.
- ALL SANITARY DRAINAGE PIPING 3" AND LARGER SHALL SLOPE 1/8" PER FOOT UNLESS NOTED OTHERWISE. ALL SANITARY DRAINAGE PIPING 2-1/2" AND SMALLER SHALL SLOPE 1/4" PER FOOT UNLESS NOTED OTHERWISE.
- REFERENCE PLUMBING FIXTURE CONNECTION SCHEDULE ON SHEET P7.1 FOR LINE SIZES NOT SHOWN TO FIXTURES/EQUIPMENT.
- ALL CLEANOUTS AND FLOOR DRAINS SHALL BE INSTALLED PLUMB AND LEVEL WITH FINISHED FLOOR ELEVATION.
- CONTRACTOR SHALL PROVIDE HANGERS AND SUPPORTS FOR SEISMIC RESTRAINT PER THE INTERNATIONAL BUILDING CODE. SEISMIC REPORT REQUIRED BY SEISMIC ENGINEER.
- ALL DRAINAGE PIPING AND PRESSURE SYSTEM PIPING SHALL BE RUN AS HIGH AS POSSIBLE TO BOTTOM OF STRUCTURE, UNLESS
- NOTED OTHERWISE. COORDINATE PIPE ROUTING WITH ALL OTHER TRADES.
- O. THE FOLLOWING PLUMBING SYSTEMS SHALL BE INSULATED: COLD WATER, HOT WATER, HOT WATER RECIRCULATION, P-TRAPS AND HORIZONTAL PIPING RECEIVING CONDENSATE ABOVE CEILINGS.
- 1. IT SHALL BE THE RESPONSIBILITY OF THE CONTRACTOR TO VERIFY THAT ITEMS TO BE FURNISHED FIT THE SPACE AVAILABLE. 2. THESE DRAWINGS ARE SCHEMATIC IN NATURE AND DO NOT SHOW EXACT LOCATIONS OF FIXTURES AND EQUIPMENT. ALL OFFSETS AND FITTINGS FOR COMPLETE INSTALLATION MAY NOT BE DEFINED ON THE DRAWINGS. CONTRACTOR SHALL BE RESPONSIBLE FOR VERIFYING EXACT DIMENSIONS AT THE BUILDING AND ANY NECESSARY CHANGES MADE IN ACCORDANCE WITH STRUCTURAL

CONDITIONS, EQUIPMENT TO BE INSTALLED AND COORDINATION WITH OTHER SYSTEMS. IF CONFLICTS CANNOT BE RESOLVED THEY

- SHALL BE BROUGHT TO THE IMMEDIATE ATTENTION OF THE ARCHITECT/ENGINEER. . CONTRACTOR SHALL COMPLY WITH THE FOLLOWING CODES AND STANDARDS INSOFAR AS THEY APPLY: NFPA 99, 2015 IBC,
- I. CONTRACTOR SHALL SECURE ALL PERMITS, INSPECTIONS, LICENSES AND TESTS REQUIRED FOR THIS WORK AND PAY ALL FEES IN CONNECTION THEREWITH.
- ALL MATERIALS SHALL BEAR THE MANUFACTURER'S NAME, TRADE NAME AND BE U.L. LABELED IF REQUIRED BY CODE. UNLESS SPECIFICALLY INDICATED OTHERWISE, ALL EQUIPMENT AND MATERIALS SHALL BE INSTALLED IN ACCORDANCE WITH THE RECOMMENDATIONS OF THE MANUFACTURER. ALL EQUIPMENT OF A SIMILAR TYPE SHALL BE OF THE SAME MANUFACTURER.
- . CONTRACTOR SHALL LOCATE AND SIZE ALL OPENINGS REQUIRED FOR PLUMBING EQUIPMENT AND PIPING; AND PROVIDE THIS

INFORMATION TO THE GENERAL CONTRACTOR IN TIME NOT TO DELAY BUILDING CONSTRUCTION.

- . CONTRACTOR SHALL PROVIDE AND LOCATE SLEEVES AND INSERTS REQUIRED BEFORE THE FLOOR AND WALLS ARE BUILT OR SHALL BE RESPONSIBLE FOR THE COST OF CUTTING AND PATCHING REQUIRED FOR PIPES WHERE SLEEVES AND INSERTS WERE NOT
- INSTALLED OR WHERE THEY WERE INCORRECTLY LOCATED. B. THE ENGINEER SHALL NOT BE RESPONSIBLE FOR THE MEANS, METHODS, TECHNIQUES, SEQUENCES OR PROCEDURES OF
- CONSTRUCTION SELECTED BY THE CONTRACTOR OR OF THE SAFETY PRECAUTIONS AND PROGRAMS INCIDENTAL TO THE WORK OF THE CONTRACTOR. THE ENGINEER SHALL NOT BE RESPONSIBLE FOR THE FAILURE OF THE CONTRACTOR TO PERFORM THE CONSTRUCTION WORK IN ACCORDANCE WITH THE DRAWINGS.
- 19. ALL WALL HUNG FIXTURES AND FLOOR MOUNTED MOP SINKS SHALL BE SEALED BETWEEN WALL AND FIXTURES WITH WHITE SILICONE CAULKING.
- 20. ALL COUNTER MOUNTED FIXTURE RIMS SHALL BE SEALED WITH SILICONE CAULKING.
- 21. LOCATE FLOOR CLEANOUTS PAST LIMITS OF THE CASEWORK.

PLUMBING AND MECHANICAL CODES.

- 22. CONTRACTOR SHALL MAKE PROVISIONS FOR EXPANSION LOOPS WHERE NECESSARY WHETHER OR NOT SHOWN ON DRAWINGS. 23. OFFSET PLUMBING VENTS AND WATER PIPING AS NECESSARY TO AVOID CONFLICTS WITH DUCTWORK. SEE HVAC PLANS.
- 24. IT IS THE INTENT AND MEANING OF THE DRAWINGS TO PROVIDE COMPLETE AND OPERABLE PLUMBING AND DRAINAGE SYSTEMS.
- 25. ALL PLUMBING LINE SIZE REDUCTIONS SHALL BE MADE WITH REDUCERS AND/OR REDUCING FITTINGS.
- 26. NO DOUBLE WYE FITTINGS OR CONNECTIONS PERMITTED. MAKE ALL SANITARY CONNECTIONS WITH OFFSET FITTINGS.

ABBREVIATIONS *

Normally Closed Access Door Not in Contract Above Finished Floor Normally Open Backflow Preventer Compressed Air Not To Scale Cast Iron Column Line CONN Connection Pump – No. Cold Water De-ionized Water Shock Absorber Expansion Tank Electric Water Cooler Floor Drain Stainless Steel Storm Drain Gallons Per Hour Temperature GPM Gallons Per Minute Top of Steel Hot Water Return Urinal Invert Elevation Vacuum Vacuum Breaker Medical Air Sanitary Vent Maximum Vent Thru Roof Minimum Sanitary Waste Male Pipe Thread Wall Box MSB-# Mop Sink Basin WC-# Water Closet Not Applicable

* Not All Abbreviations Used

REQUIRED WORK SEQUENCE:

A. Construct Work in stages during construction period:

B. Coordinate construction schedule and operations with Owner.

Date of Commencement.

1. Stage 1: [2nd Floor alterations]. Achieve full certificate of occupancy, including life safety system operational inspection and all other final completion requirements, by October 16, 2019. 2. Stage 2: [1st Floor alterations (if alternate is accepted)]. Achieve full

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C. Work on the 1st floor that supports the Work on the 2nd floor functionally (such as ducts, shafts, vertical piping and infrastructure, etc.) is to be included in Stage 1

PROJECT # FP00000285 National Pipe Thread GMK project number Over Flow Storm Drain PROJECT # 16070.03/H27-D339-ID Pressure Reducing Valve Pounds Per Square Inch

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No. CO0287

1300 PICKENS STREET

BARRINGER HOUSE

RENOVATIONS

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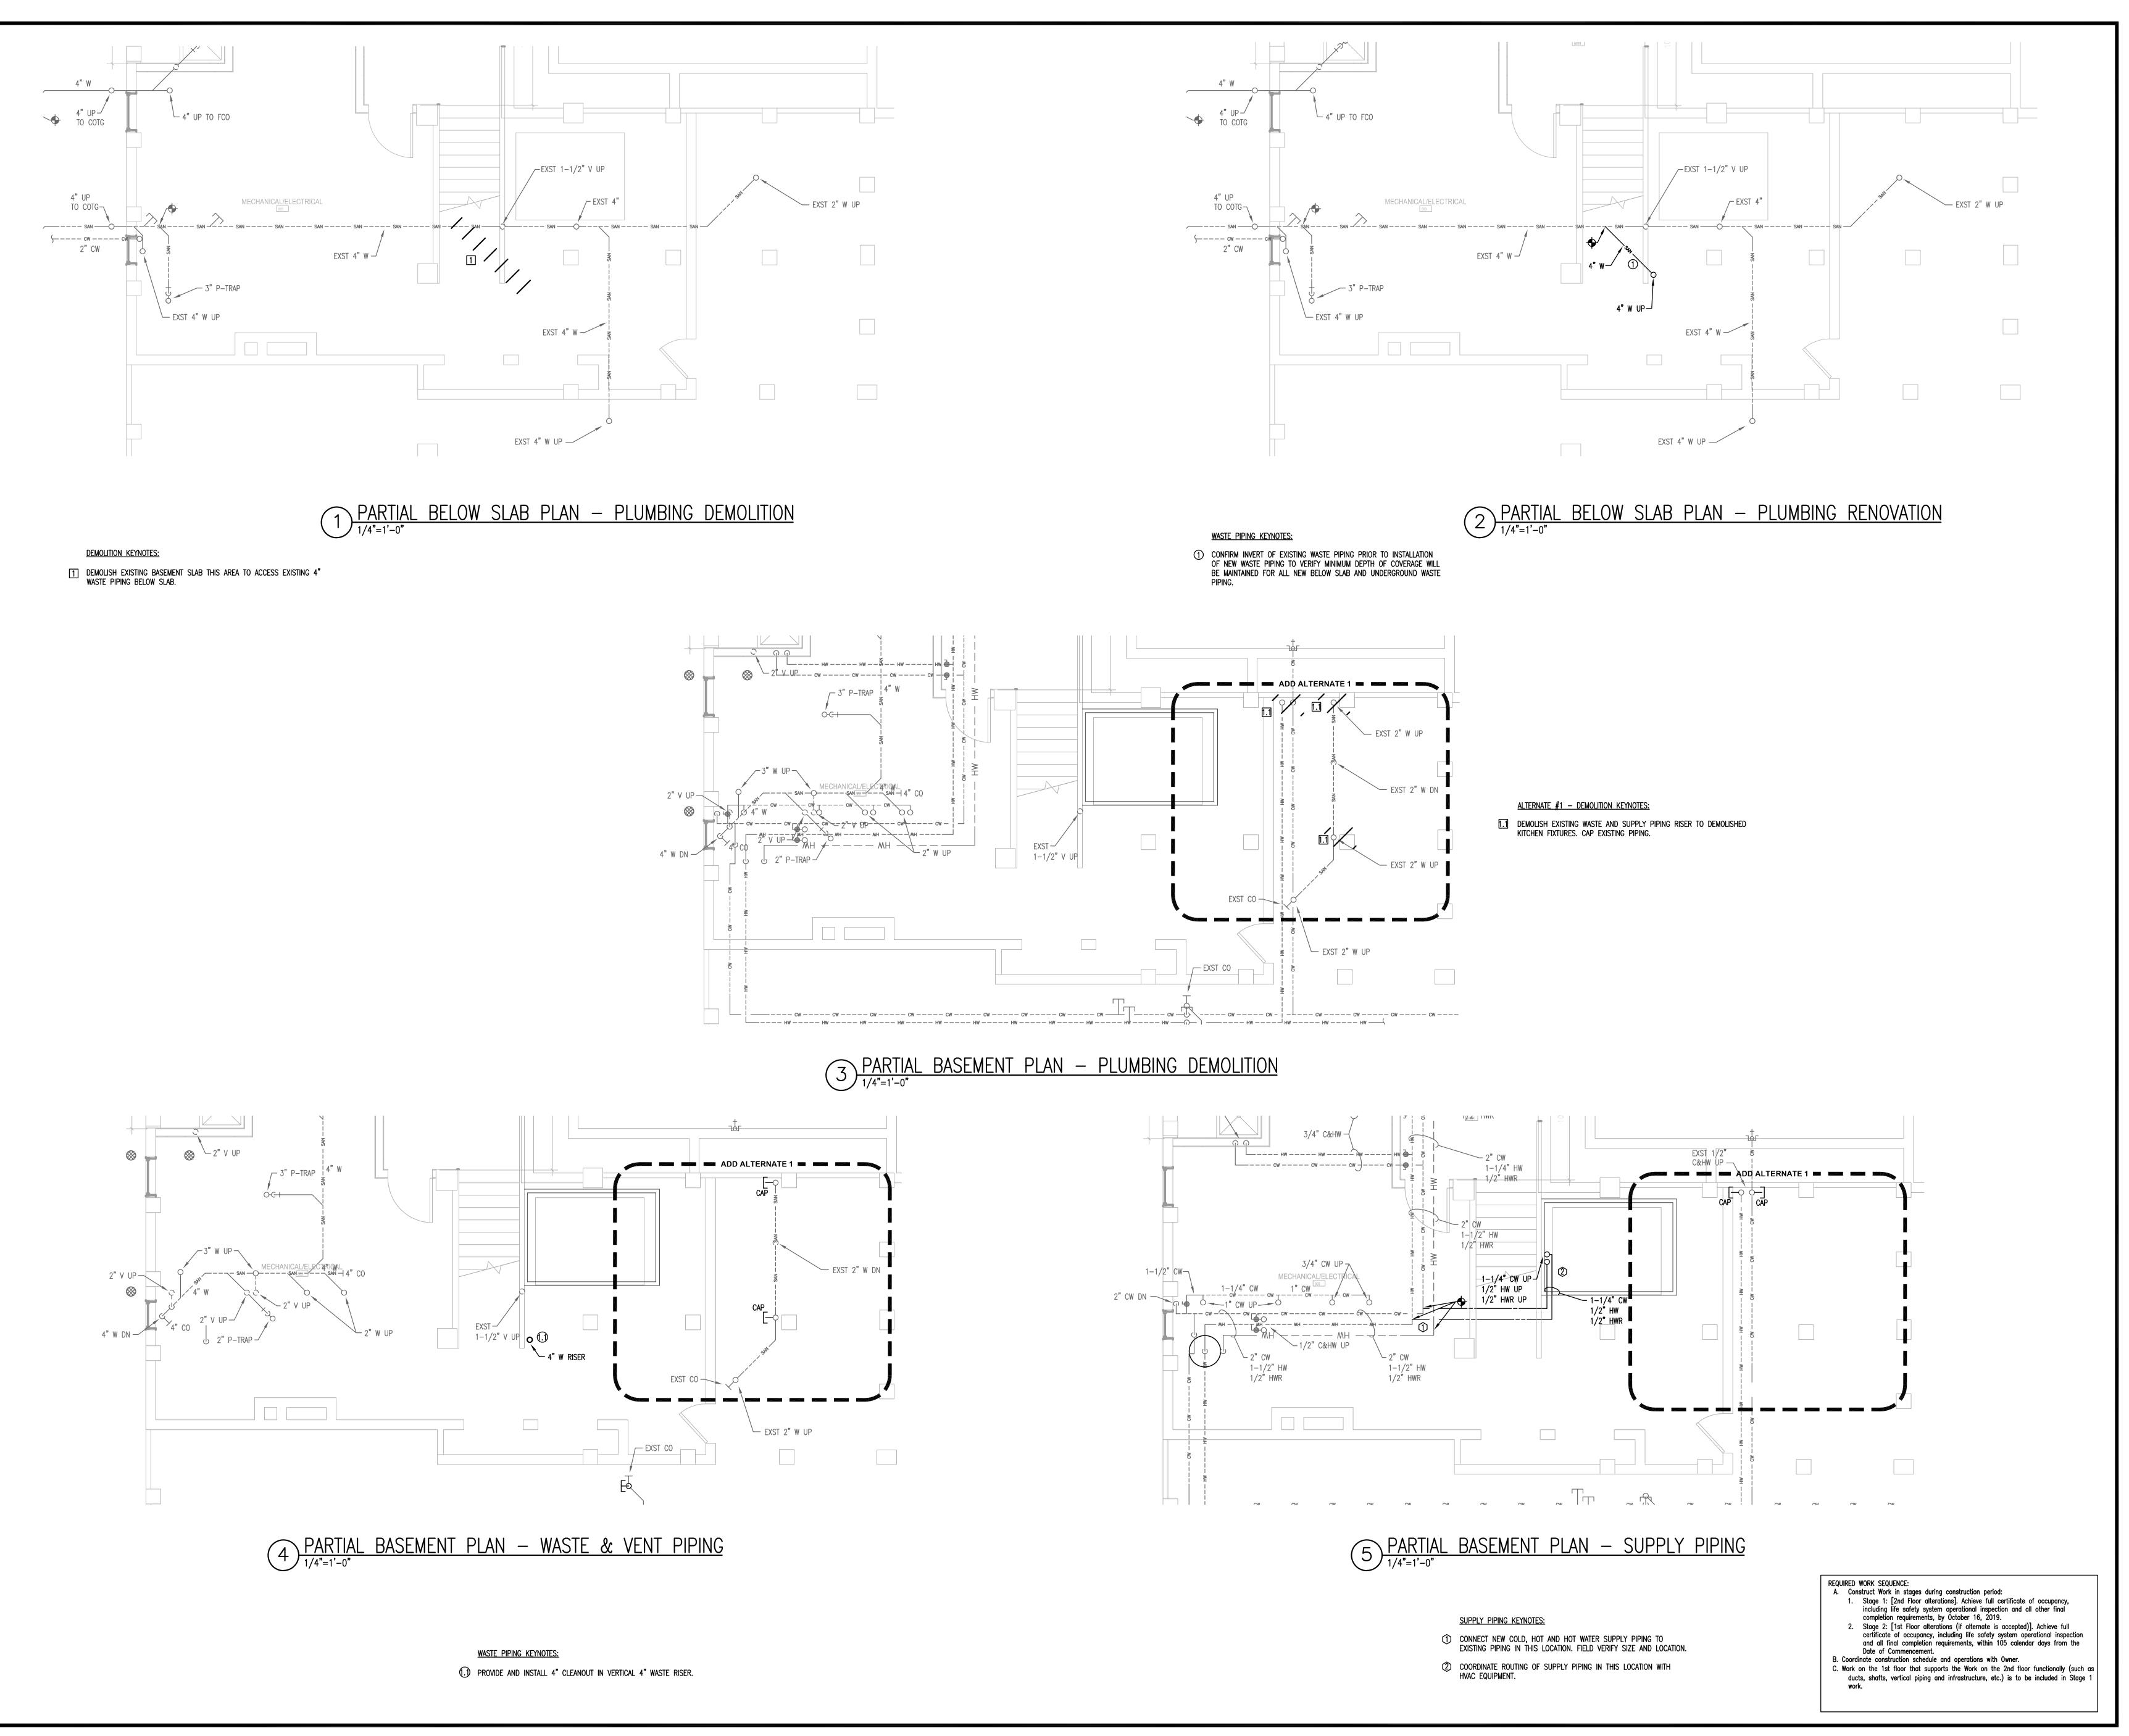
AUGUST 2, 2019



PLUMBING DETAILS, NOTES, **LEGEND, ABBREVIATIONS** & SCHEDULES

sheet number

drawn by JJR checked by JWB



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PROJECT # FP00000285


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PARTIAL BASEMENT & BELOW SLAB PLUMBING PLANS


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drawn by JJR checked by JWB


ALTERNATE #1 - PLUMBING DEMOLITION KEYNOTES:

- DEMOLISH AND REMOVE EXISTING FIXTURE DEMOLISH EXISTING WASTE AND SUPPLY PIPING BELOW FLOOR AND CAP IN BASEMENT. FIELD VERIFY SIZE AND LOCATION OF EXISTING.
- DEMOLISH EXISTING VENT PIPING TO MAIN VENT PIPING AS SHOWN ON SHEET P1.2 AND CAP. FIELD VERIFY SIZE AND LOCATION OF EXISTING.
- 3 EXISTING PLUMBING SHALL REMAIN CAPPED BELOW FLOOR ON SECOND FLOOR. ACCESS TO PIPING SHALL BE FROM SECOND FLOOR ABOVE.

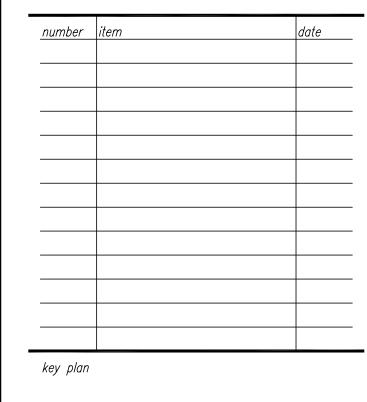

PARTIAL FIRST FLOOR PLAN — PLUMBING DEMOLITION

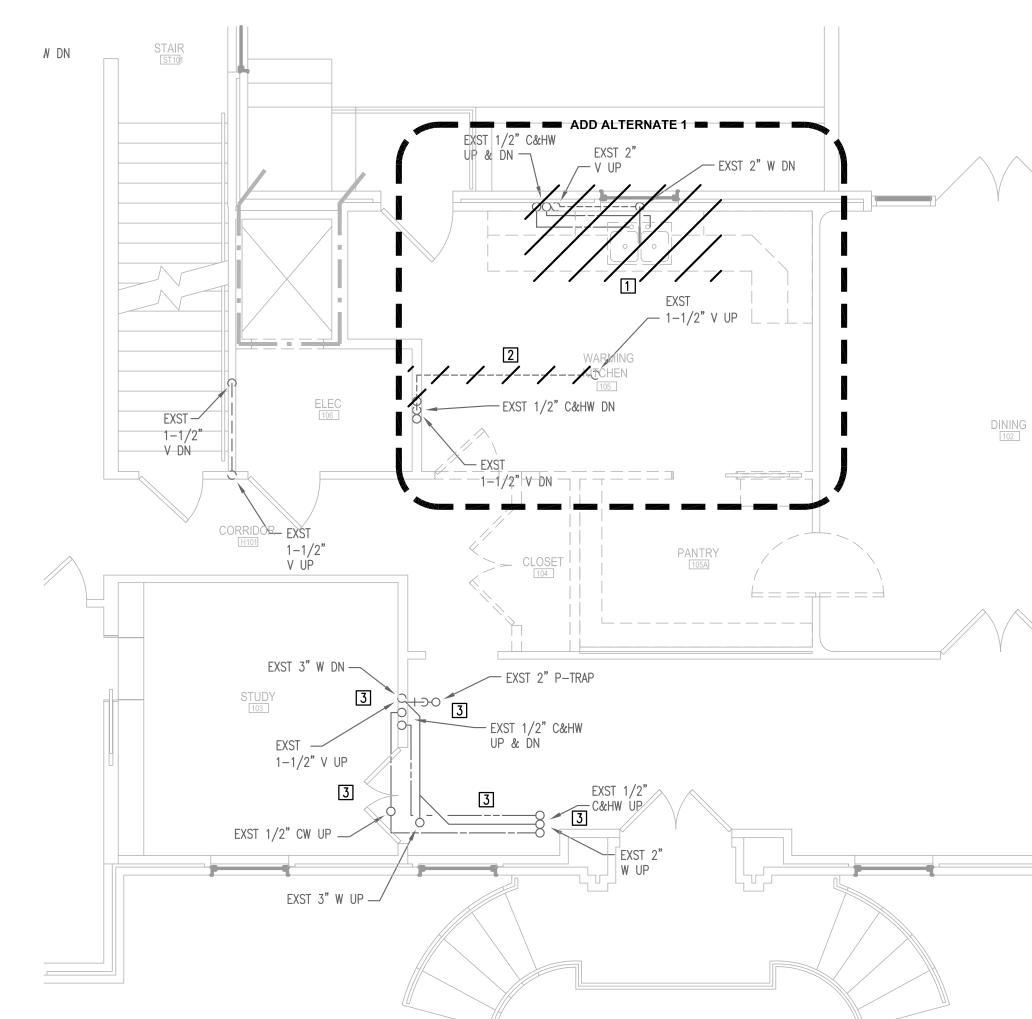1/4"=1'-0"

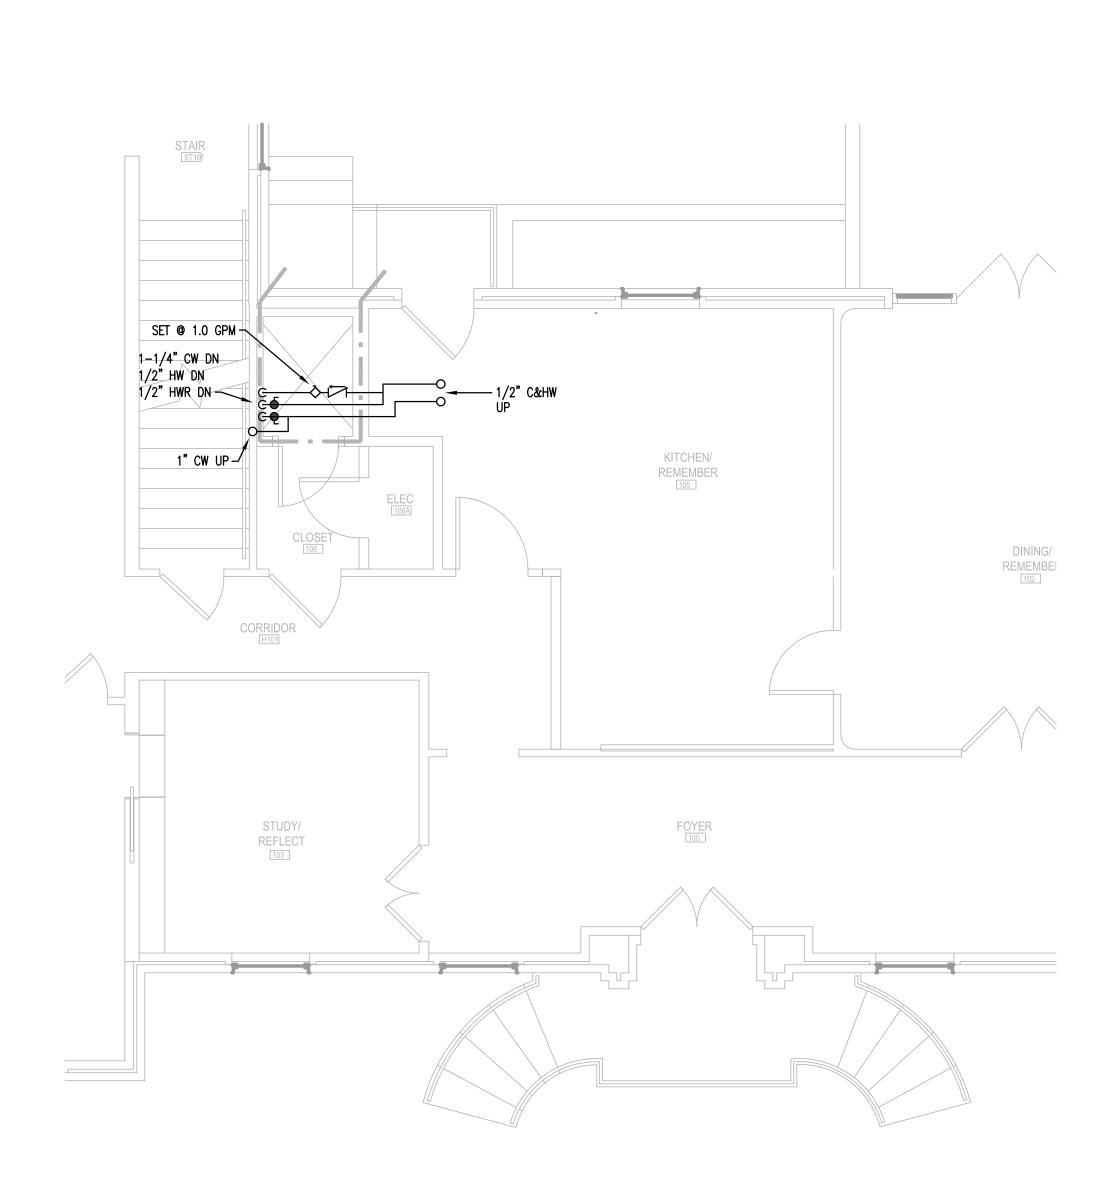

3 PARTIAL FIRST FLOOR PLAN — SUPPLY PIPING

A. Construct Work in stages during construction period:

Stage 1: [2nd Floor alterations]. Achieve full certificate of occupancy, including life safety system operational inspection and all other final completion requirements, by October 16, 2019.
Stage 2: [1st Floor alterations (if alternate is accepted)]. Achieve full certificate of occupancy, including life safety system operational inspection and all final completion requirements, within 105 calendar days from the Date of Commencement.

B. Coordinate construction schedule and operations with Owner.
C. Work on the 1st floor that supports the Work on the 2nd floor functionally (such as ducts, shafts, vertical piping and infrastructure, etc.) is to be included in Stage 1 work.

REQUIRED WORK SEQUENCE:

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PROJECT # 16070.03/H27-D339-ID

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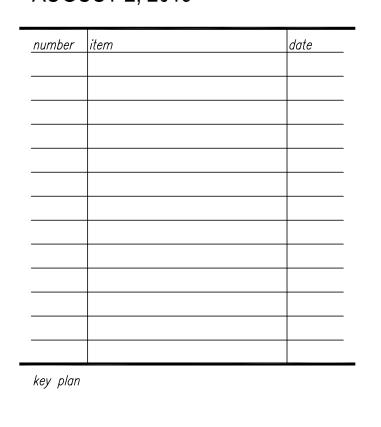
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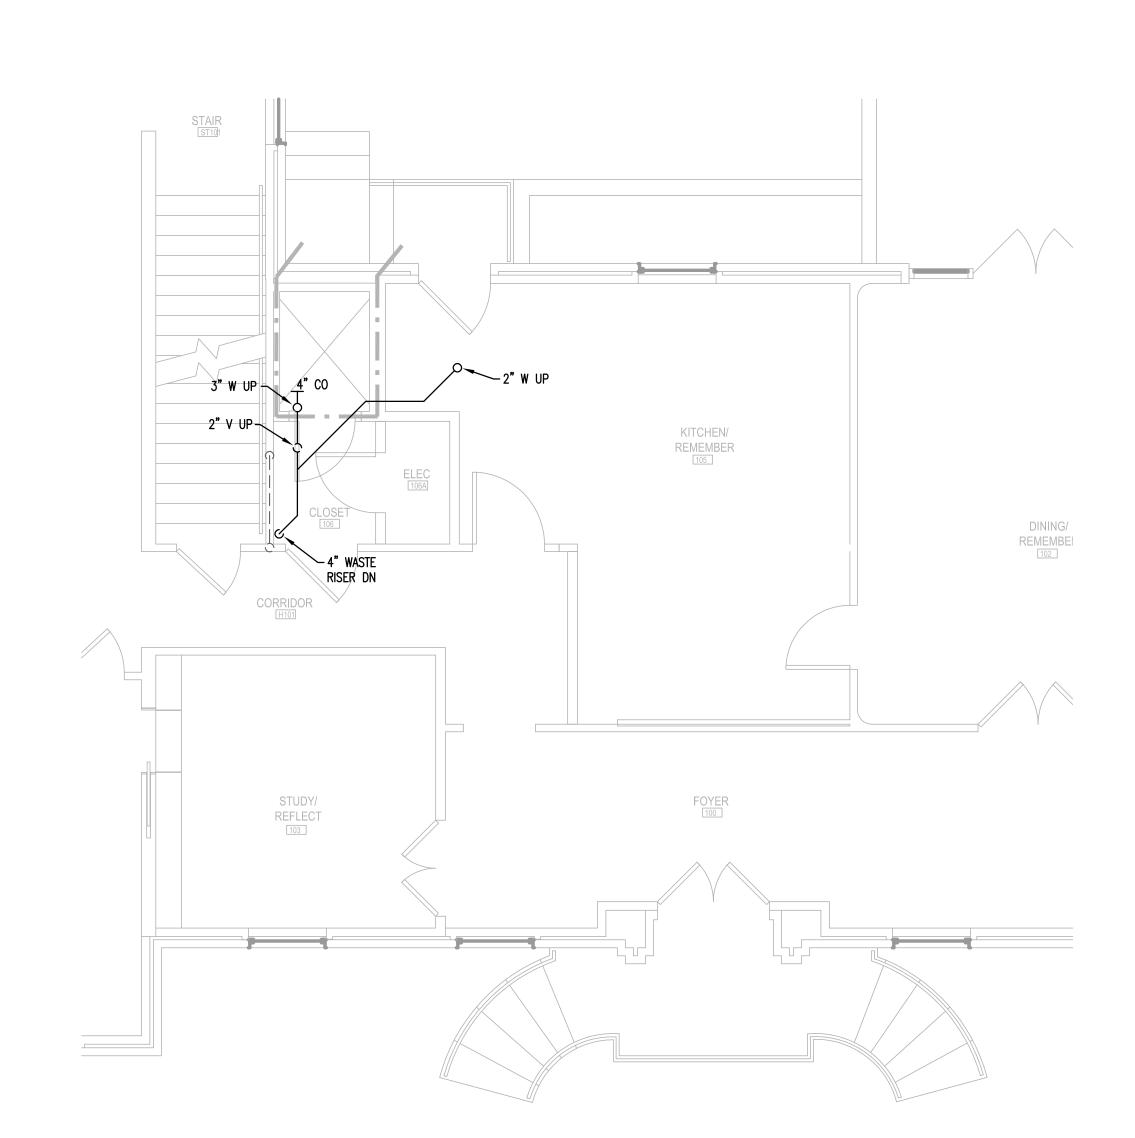


PARTIAL FIRST FLOOR PLUMBING PLANS


sheet number

P1.1

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checked by JWB



2 PARTIAL FIRST FLOOR PLAN — WASTE & VENT PIPING

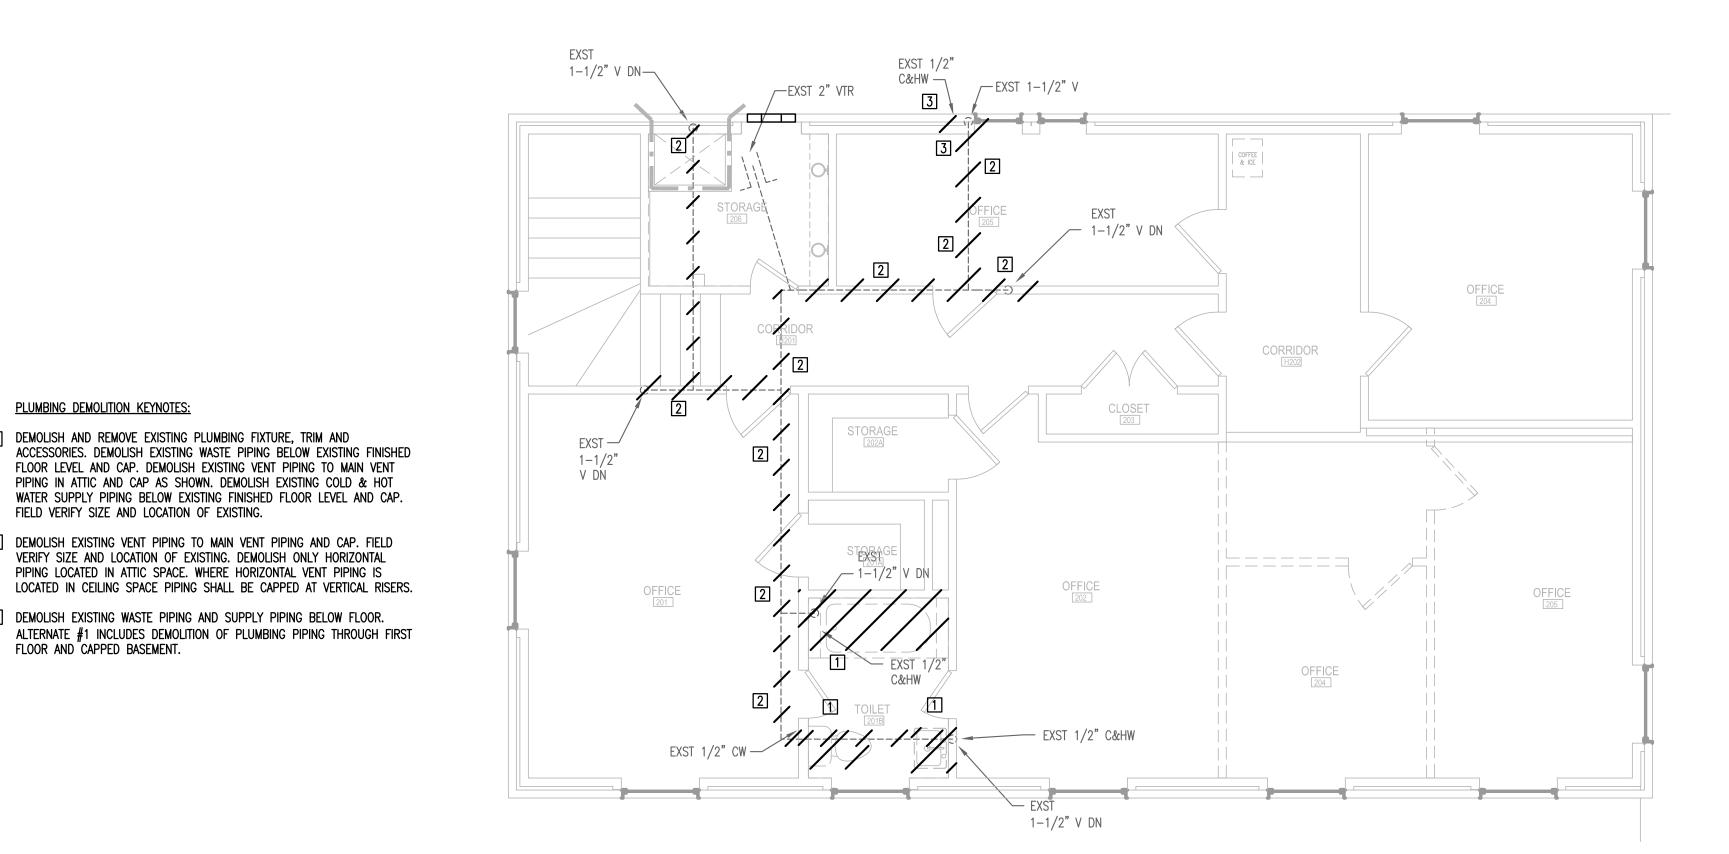

PLUMBING DEMOLITION KEYNOTES:

FLOOR AND CAPPED BASEMENT.


1 DEMOLISH AND REMOVE EXISTING PLUMBING FIXTURE, TRIM AND

FLOOR LEVEL AND CAP. DEMOLISH EXISTING VENT PIPING TO MAIN VENT PIPING IN ATTIC AND CAP AS SHOWN. DEMOLISH EXISTING COLD & HOT

DEMOLISH EXISTING VENT PIPING TO MAIN VENT PIPING AND CAP. FIELD VERIFY SIZE AND LOCATION OF EXISTING. DEMOLISH ONLY HORIZONTAL

3 DEMOLISH EXISTING WASTE PIPING AND SUPPLY PIPING BELOW FLOOR.

1 PARTIAL SECOND FLOOR PLAN - PLUMBING DEMOLITION

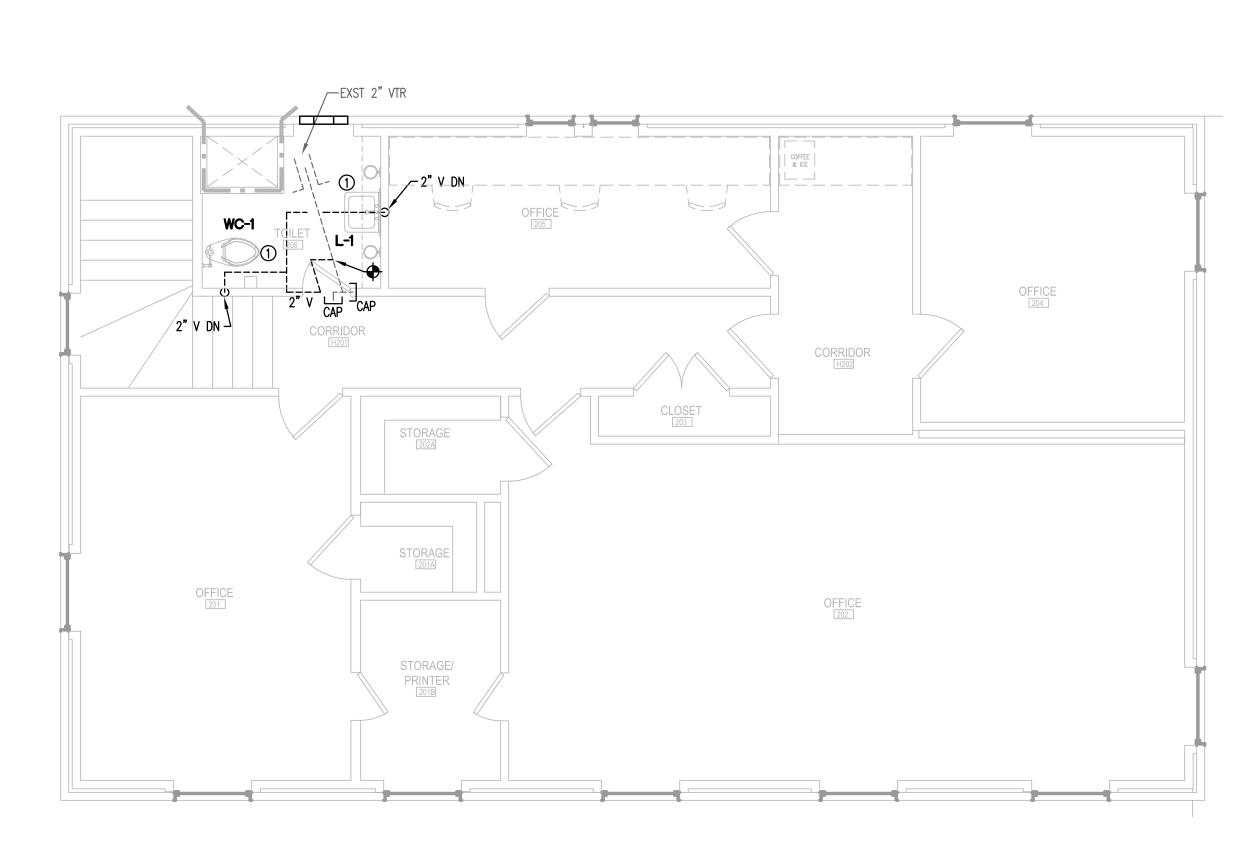


2 PARTIAL SECOND FLOOR PLAN - WASTE & VENT PIPING

WASTE PIPING KEYNOTES:

EXISTING VTR IN ATTIC SPACE.

PROVIDE AND INSTALL NEW FIXTURE. CONNECT WASTE PIPING TO EXISTING WASTE RISER IN BASEMENT. CONNECT VENT PIPING TO

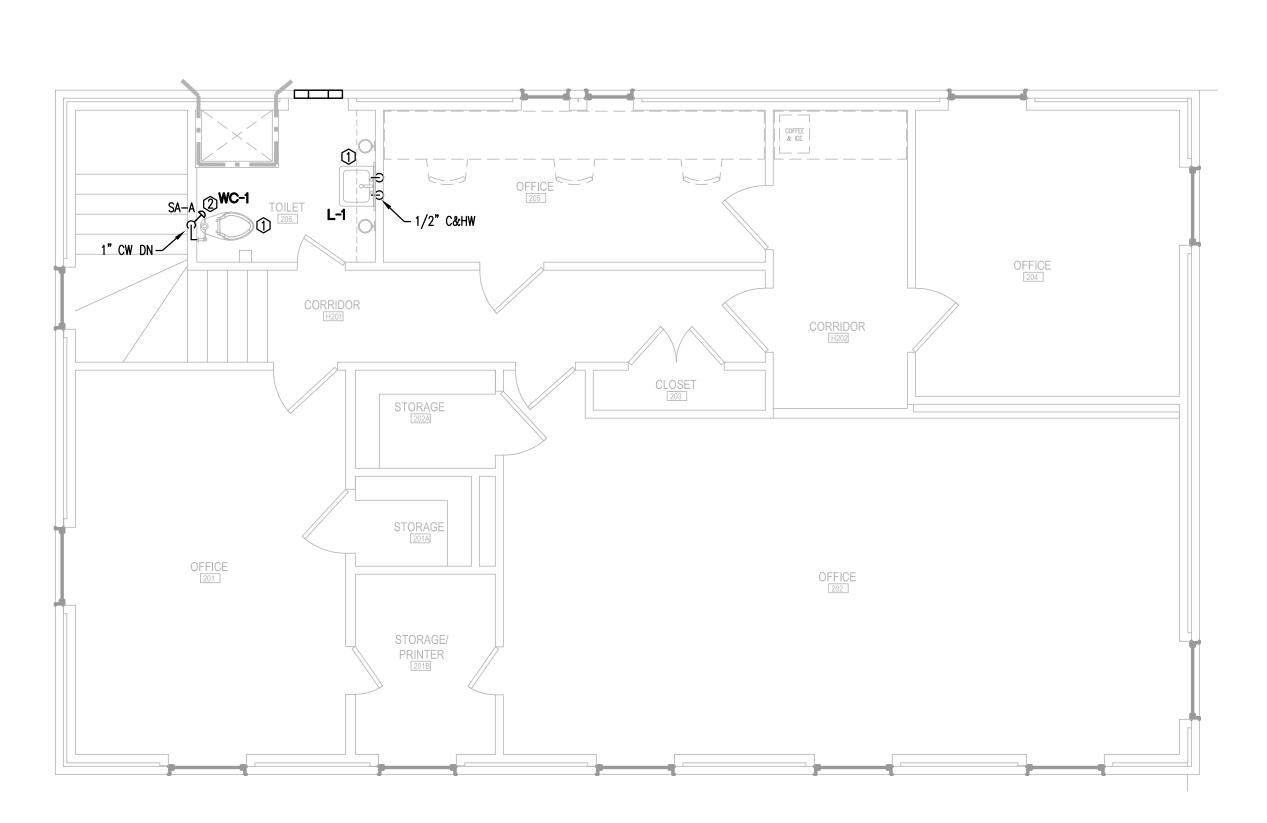

3 PARTIAL SECOND FLOOR PLAN - SUPPLY PIPING

- PROVIDE AND INSTALL NEW PLUMBING FIXTURE. CONNECT TO NEW WATER PIPING AS SHOWN.
- ② PROVIDE AND INSTALL NEW ACCESS PANEL FOR FIXTURE MAINTENANCE. COORDINATE LOCATION OF COLD WATER SUPPLY SHOCK ABSORBER WITH ACCESS PANEL.

A. Construct Work in stages during construction period:

1. Stage 1: [2nd Floor alterations]. Achieve full certificate of occupancy, including life safety system operational inspection and all other final completion requirements, by October 16, 2019. Stage 2: [1st Floor alterations (if alternate is accepted)]. Achieve full
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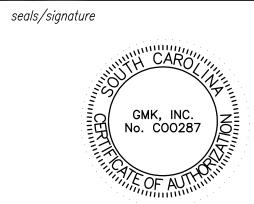
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project name BARRINGER HOUSE RENOVATIONS


State project number PROJECT # FP00000285 GMK project number PROJECT # 16070.03/H27-D339-ID





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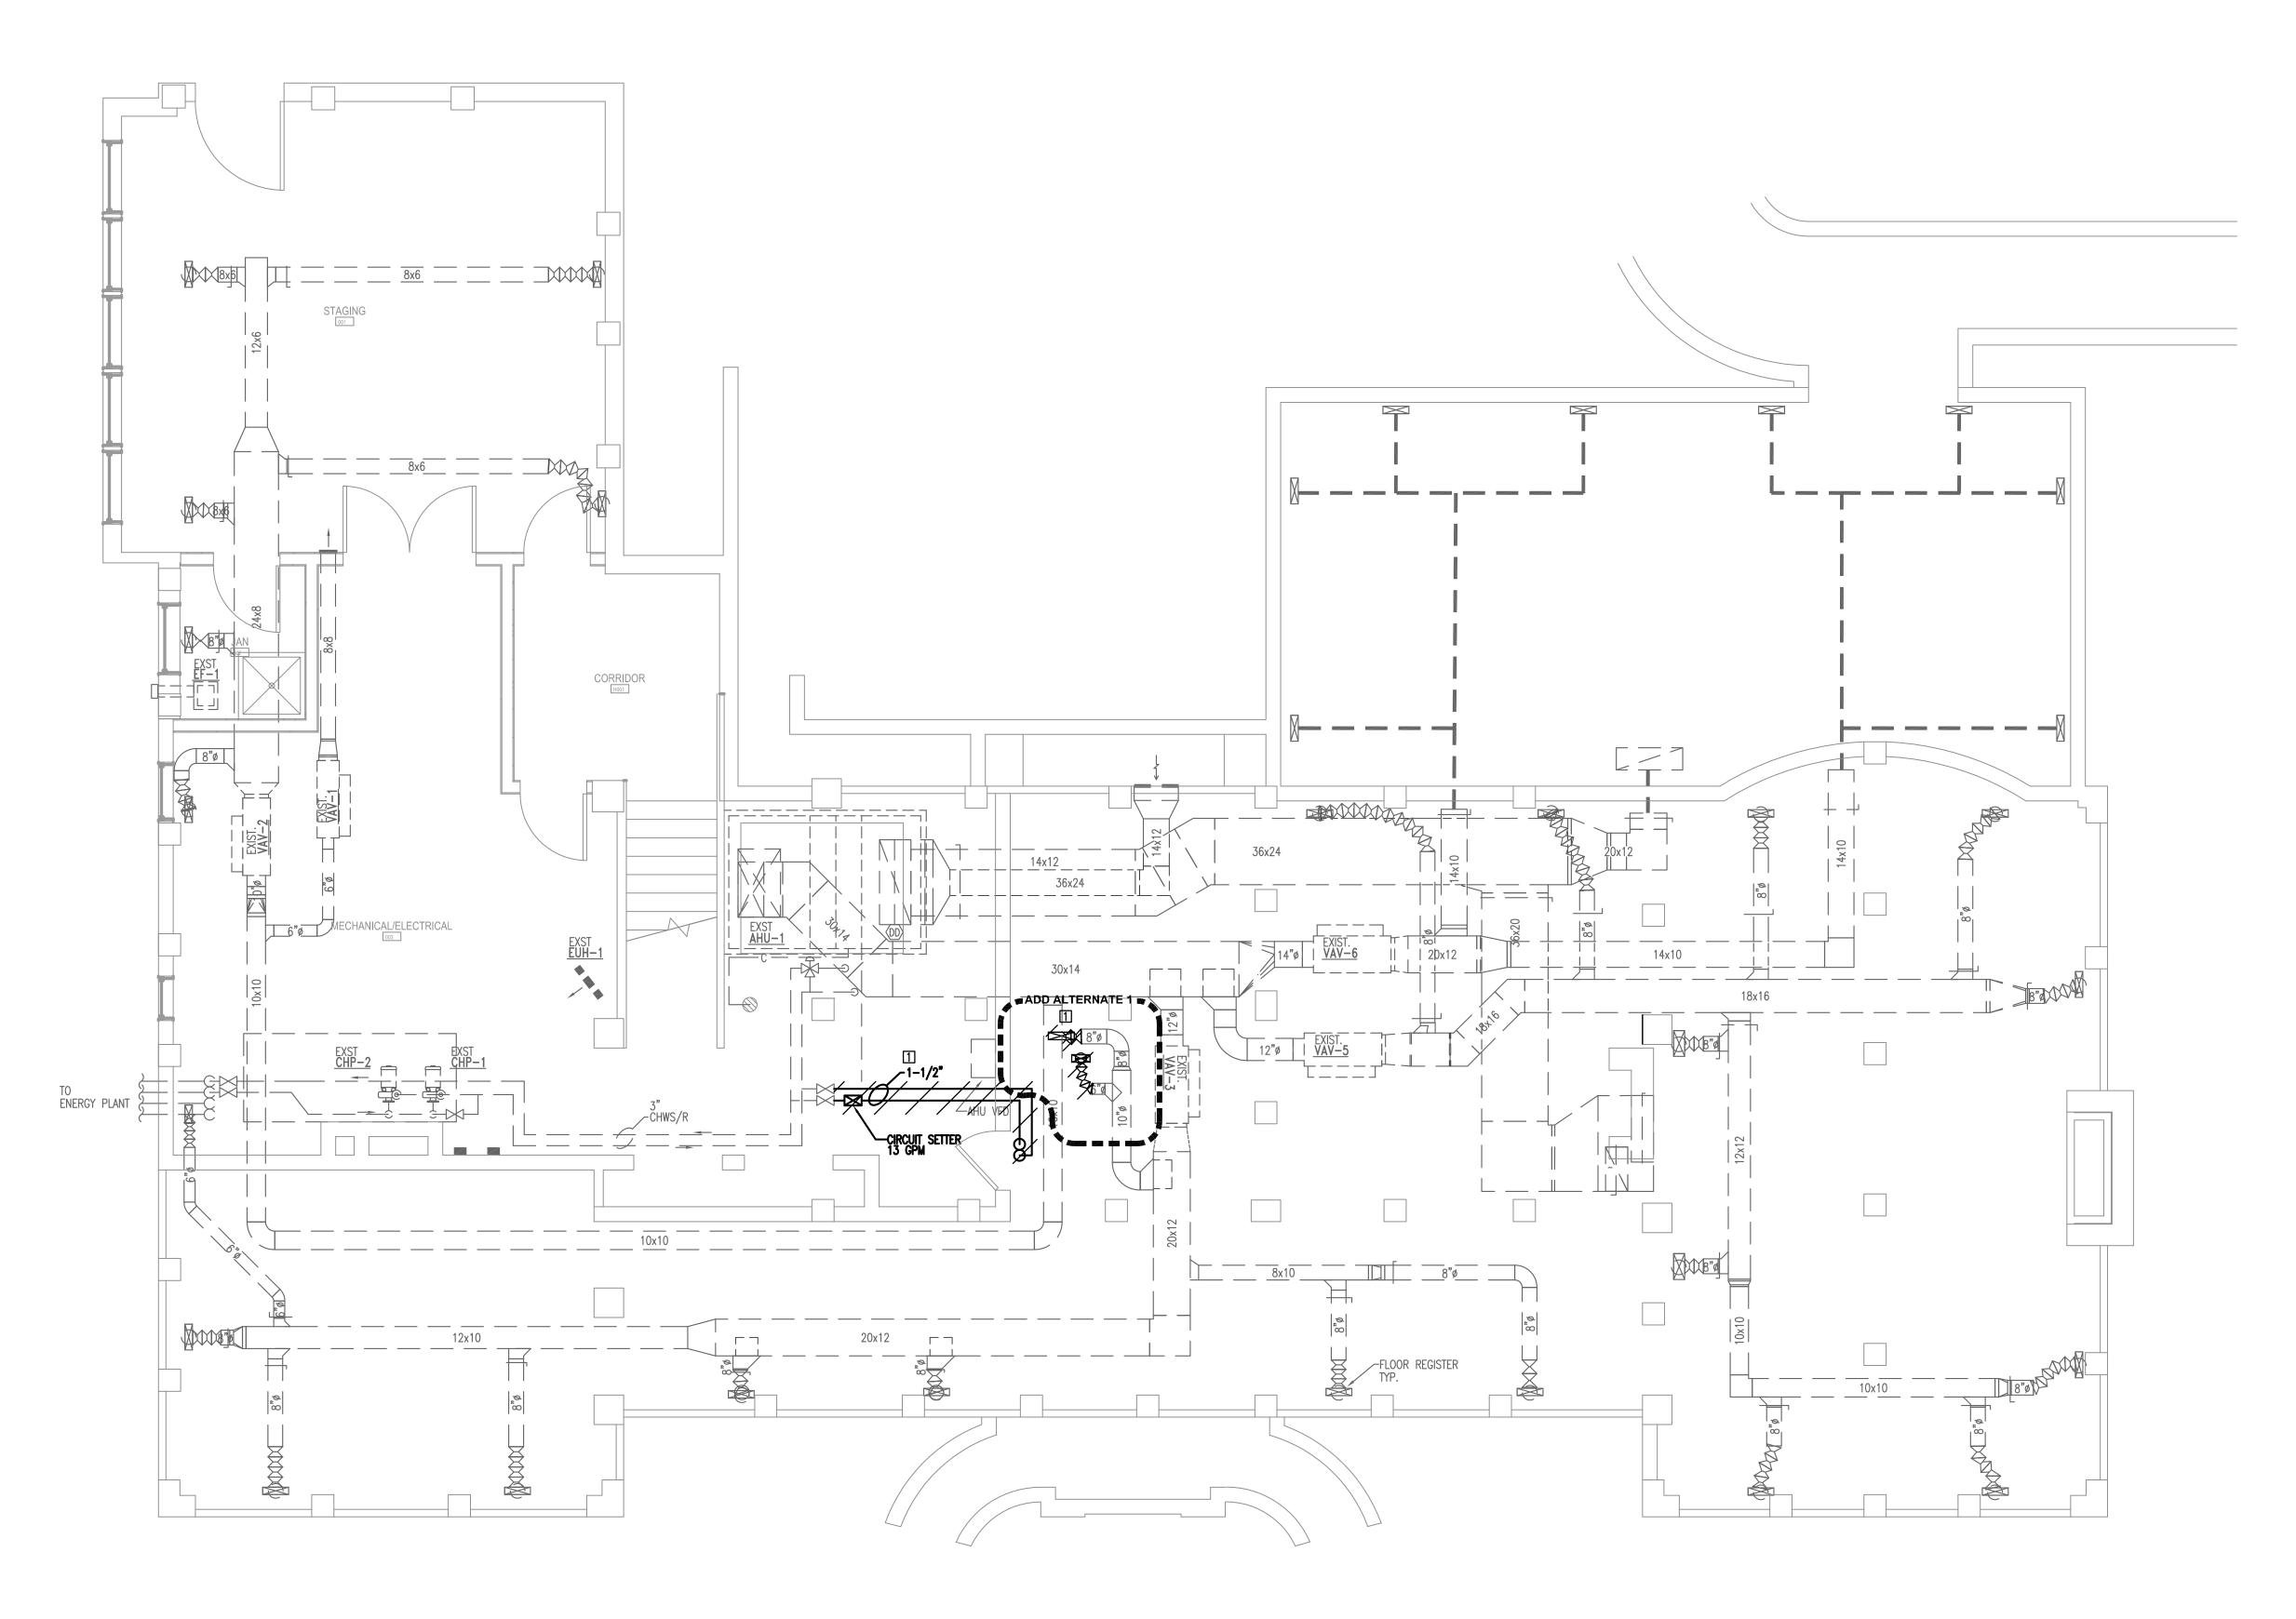


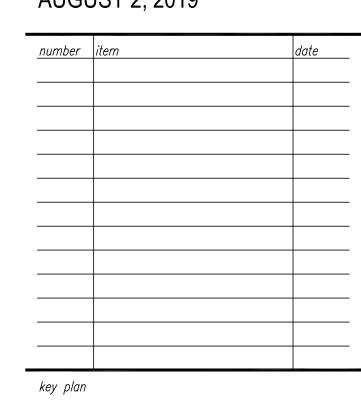

PARTIAL SECOND FLOOR PLUMBING PLANS

sheet number

drawn by JJR checked by JWB



1) BASEMENT FLOOR LEVEL - HVAC DEMOLITION

DEMOLITION KEYNOTES:

[1] REMOVE ALL EXISTING EQUIP, DUCTWORK AND PIPING. CONTRACTOR SHALL FIELD VERIFY EXTENT OF DEMOLITION PRIOR TO BIDDING.

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project name
BARRINGER HOUSE
RENOVATIONS

State project number

PROJECT # FP00000285


GMK project number

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PROJECT # 16070.03/H27-D33

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HVAC
DEMOLITION
BASEMENT PLAN

sheet number

M1.0

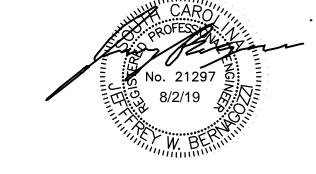drawn by JWB
checked by JDR

REQUIRED WORK SEQUENCE:

A. Construct Work in stages during construction period:


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infrastructure, etc.) is to be included in Stage 1 work.



1 FIRST FLOOR LEVEL - HVAC DEMOLITION

DEMOLITION KEYNOTES:

1 RELOCATE EXISTING FLOOR GRILLE
2 RELOCATE AND RE-WIRE EXISTING TEMPERATURE SENSOR RE-LOCATE AND RE-BALANCE EXISTING SUPPLY GRILLE
REMOVE EXISTING ABANDONED DUCTWORK IN SOFFIT BEING DEMOLISHED.
REMOVE ASSOCIATED WALL LOUVER. PATCH AND REPAIR EXTERIOR WALL ALL RIGHTS RESERVED. THIS DRAWING AND THE DESIGN SHOWN THEREON ARE COPYRIGHTED AS PRESCRIBED BY THE LAWS OF THE UNITED STATES AND ARE THE PROPERTY OF GMK ASSOCIATES ARCHITECTURAL DIVISION. ANYONE DUPLICATING, REPRODUCING OR CAUSING TO BE REPRODUCED THE WHOLE OR PART OF THESE DRAWINGS OR THE DESIGN THEREON WITHOUT PERMISSION OF THE ARCHITECT WILL BE SUBJECT TO LEGAL ACTION.
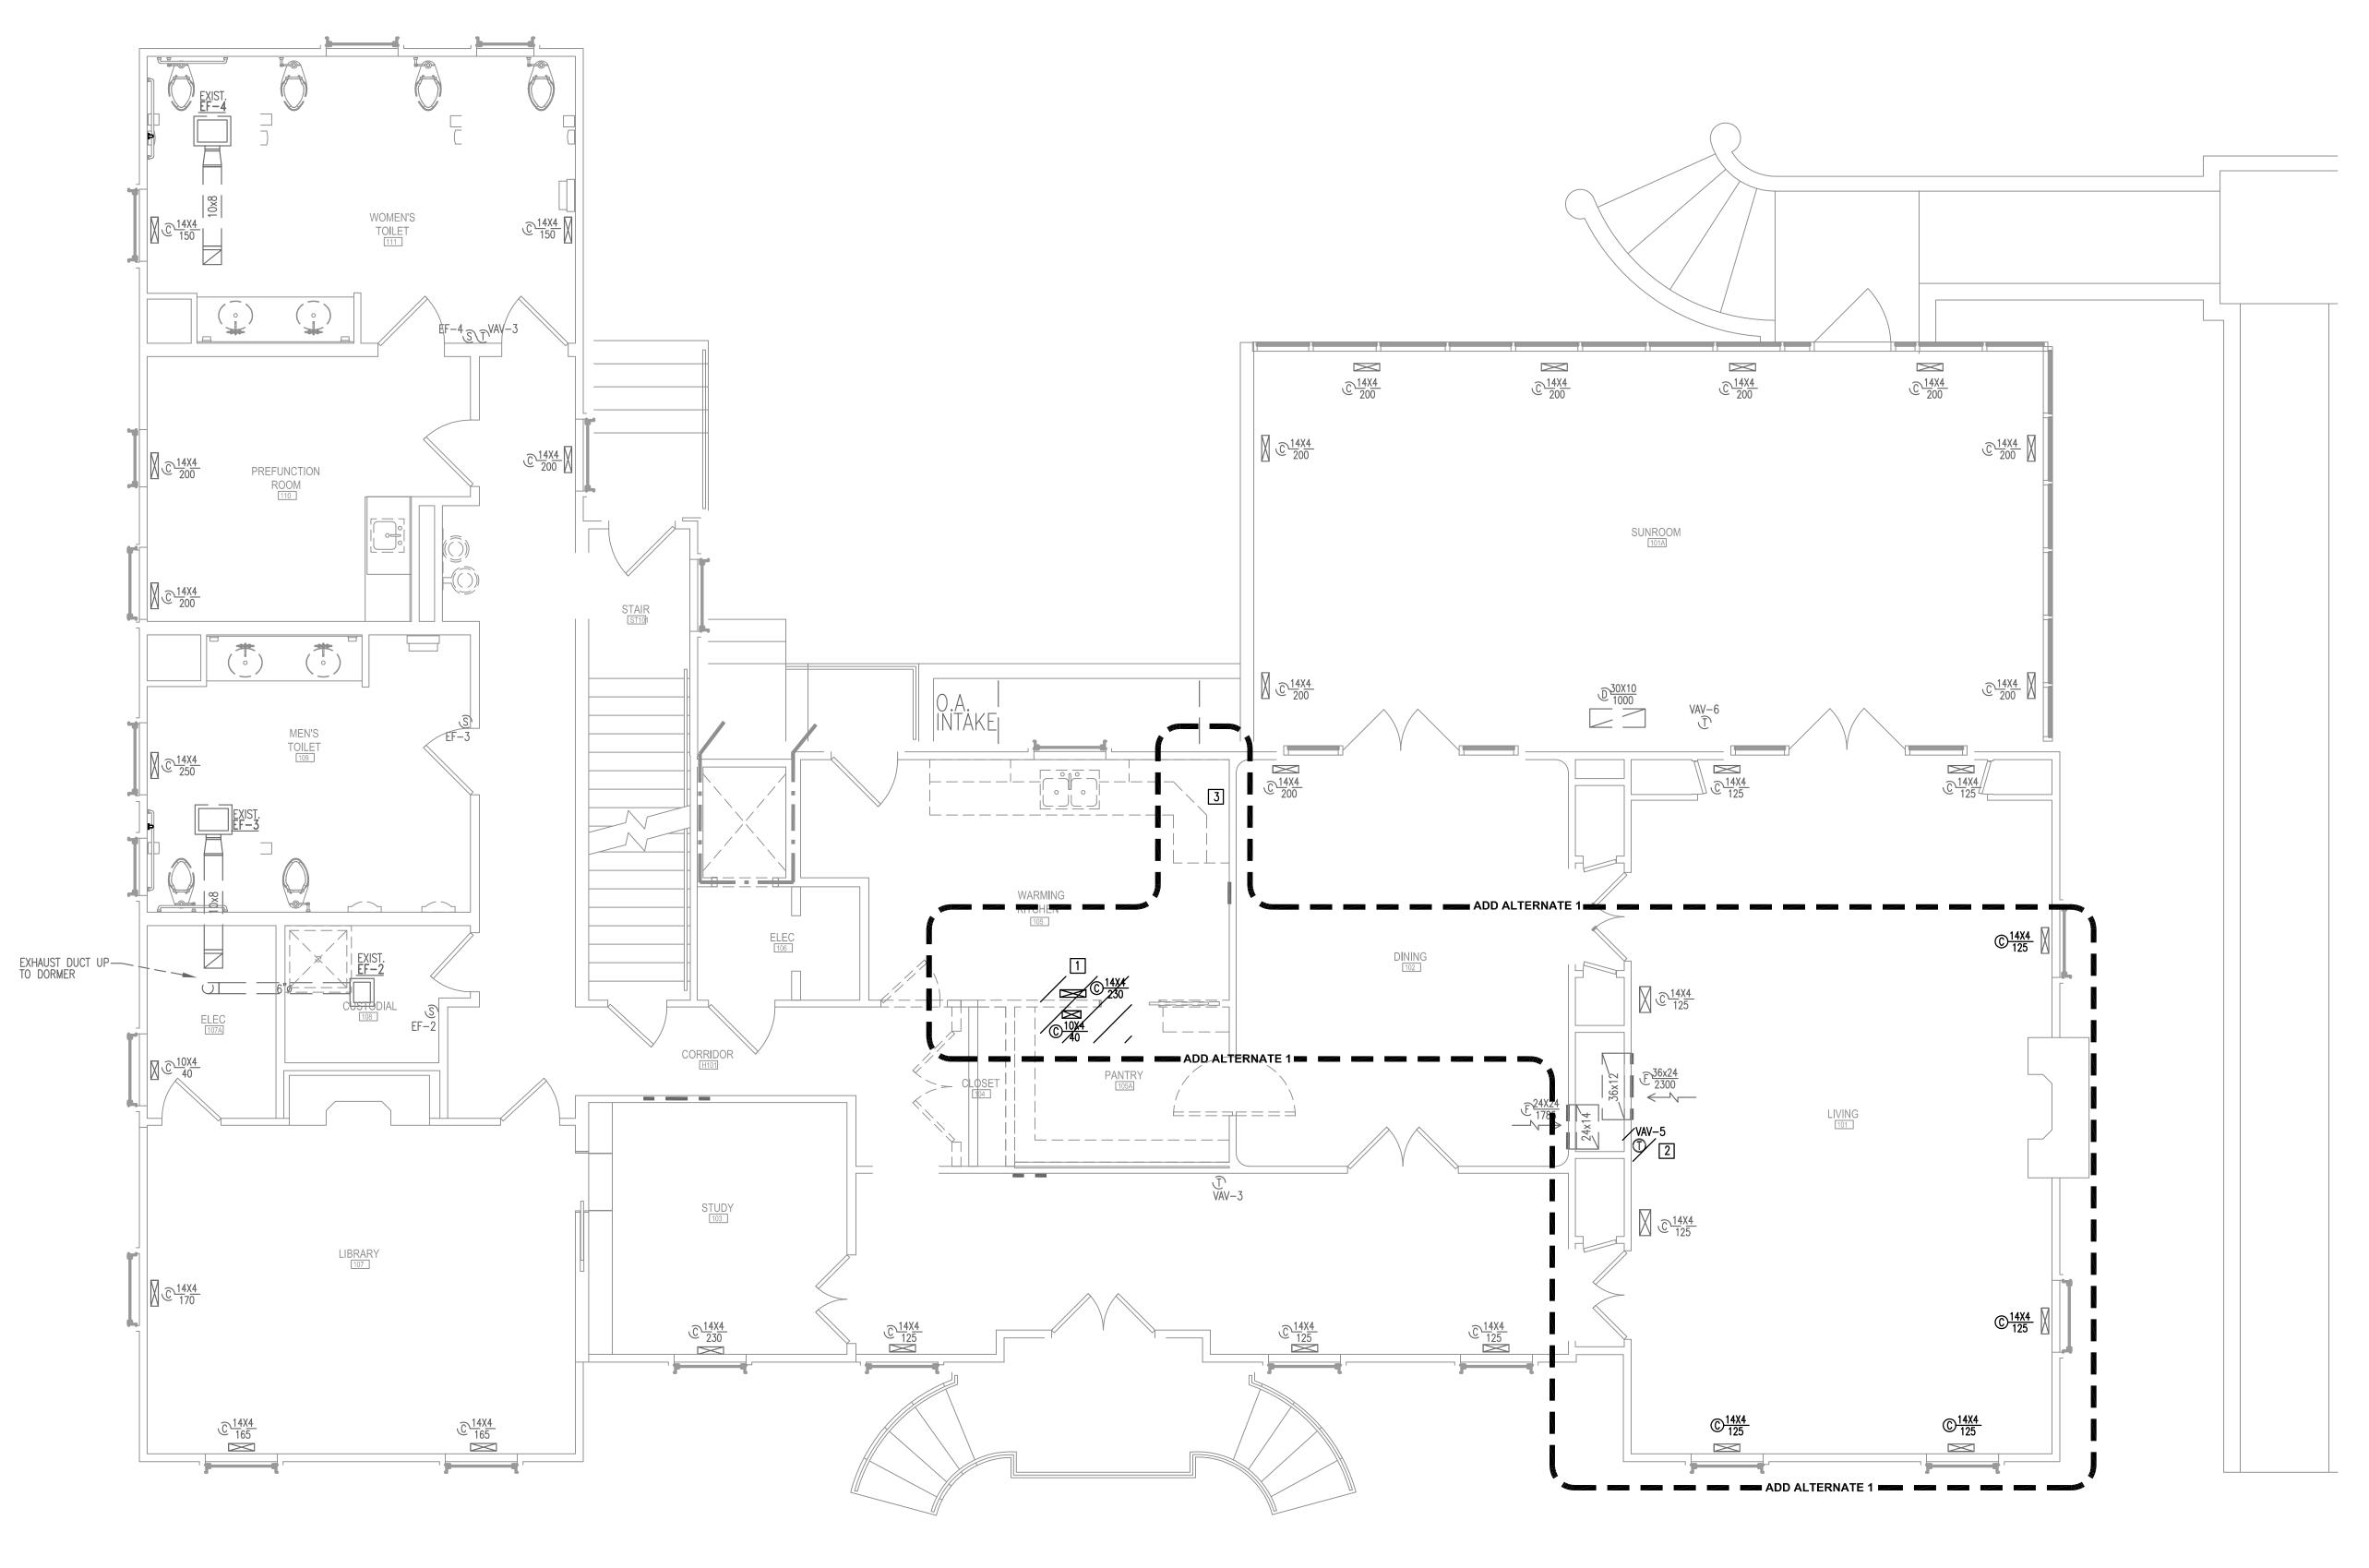
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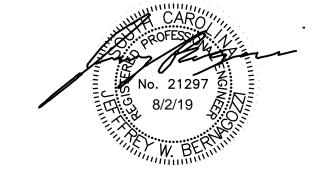
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project name BARRINGER HOUSE RENOVATIONS

State project number PROJECT # FP00000285 GMK project number PROJECT # 16070.03/H27-D339-ID

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HVAC **DEMOLITION** FIRST FLOOR PLAN

sheet number


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C. Work on the 1st floor that supports the Work on the 2nd

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SECOND FLOOR PLAN — HVAC DEMOLITION

1/4"=1'-0"

<u>DEMOLITION KEYNOTES:</u>

1 REMOVE ALL EXISTING EQUIP, DUCTWORK AND PIPING. CONTRACTOR SHALL FIELD VERIFY EXTENT OF DEMOLITION PRIOR TO BIDDING.

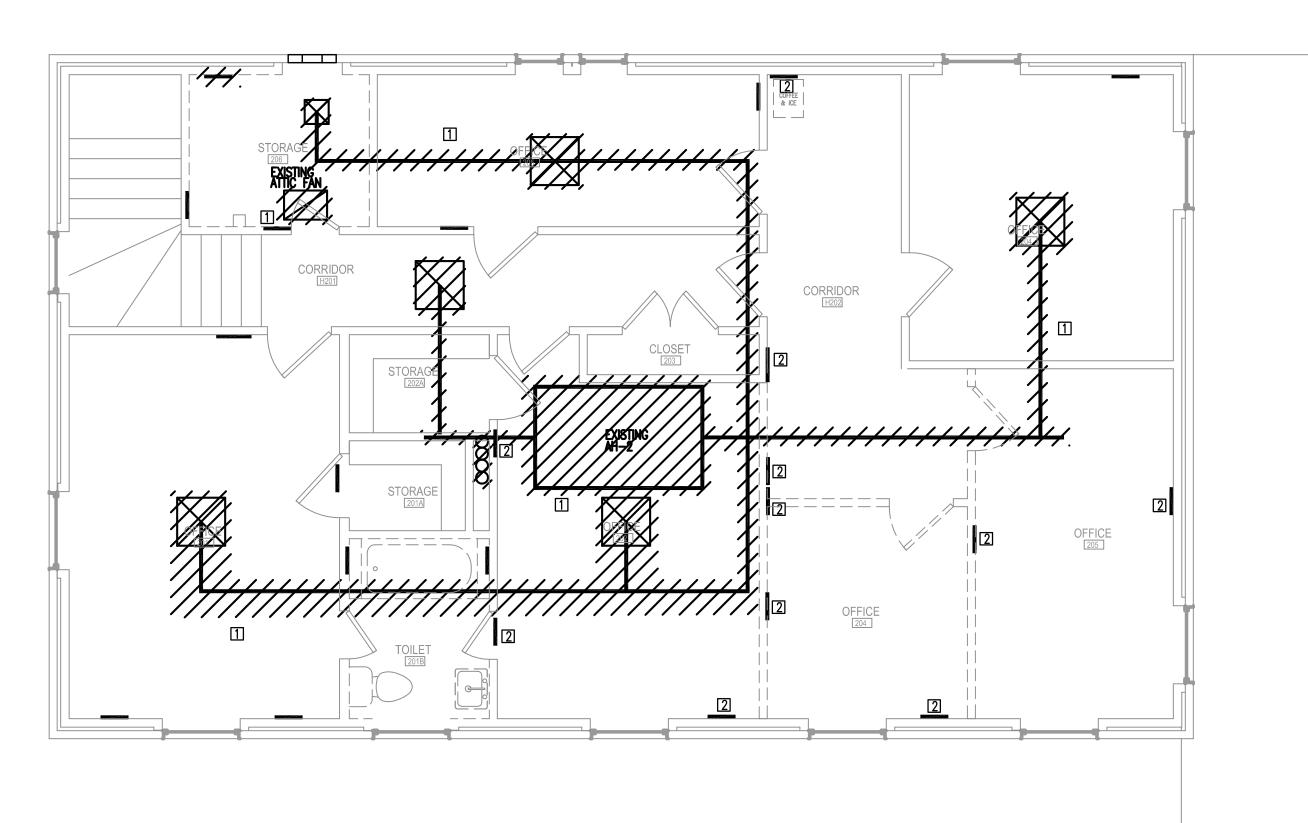[2] REMOVE EXISTING GRILLE CONTRACTOR SHALL CAP DUCT AND REPAIR WALL. ASSOCIATES, INC.

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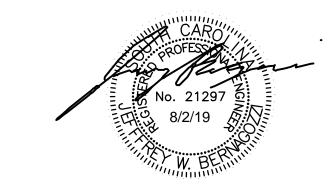


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CONSTRUCTION DOCUMENTS

^{date} AUGUST 2, 2019

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key plan



HVAC **DEMOLITION** SECOND FLOOR PLAN

sheet number


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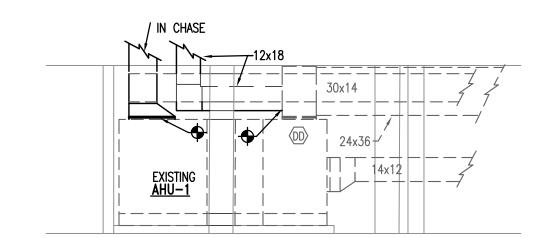
1 BASEMENT FLOOR LEVEL - HVAC RENOVATION

RENOVATION KEYNOTES:

(1) RE-SET VAV BOX TO 1700 CFM MAX AND 700 CFM MIN.

(2) CAP DUCT

(3) RE-LOCATE FLOOR GRILLE TO THIS APPROX. LOCATION. SEE M2.1

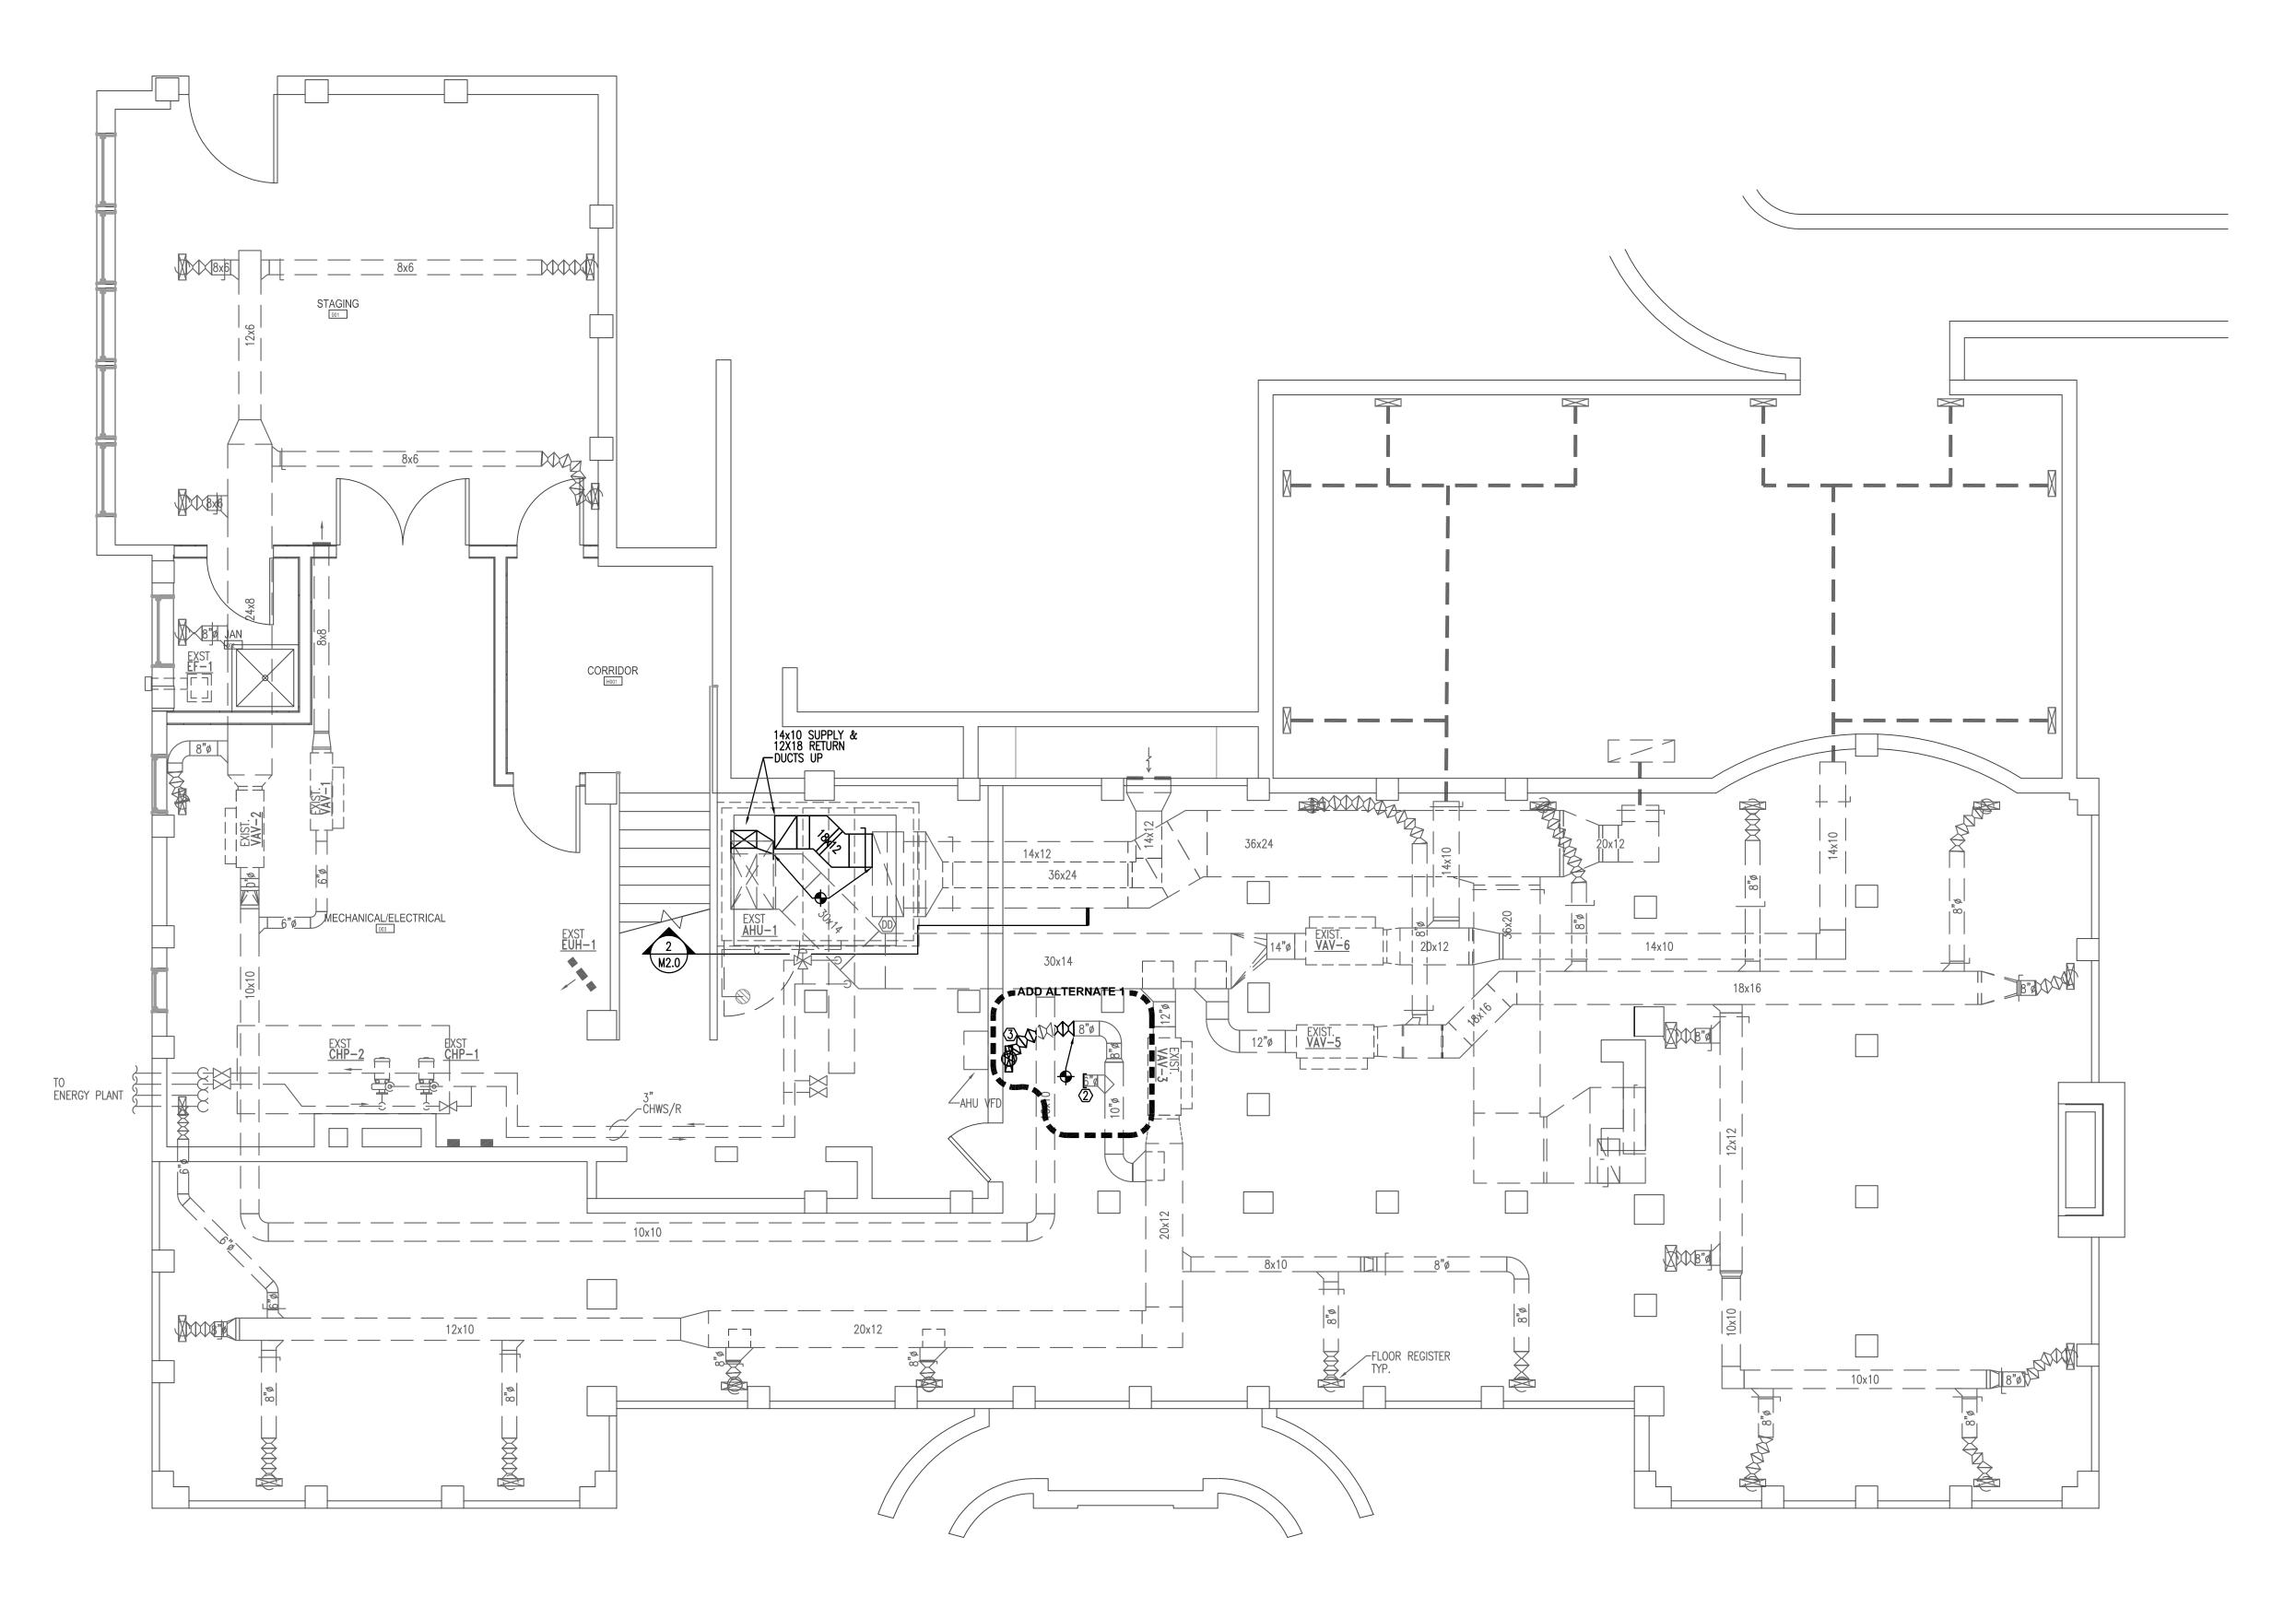

(2)AHU-1 SECTION VIEW

REQUIRED WORK SEQUENCE:

A. Construct Work in stages during construction period:

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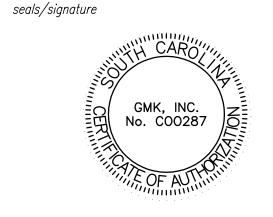



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1300 PICKENS STREET
COLUMBIA, SOUTH CAROLINA 29208

project name
BARRINGER HOUSE
RENOVATIONS

PROJECT # FP00000285

GMK project number
PROJECT # 16070.03/H27-D339-ID




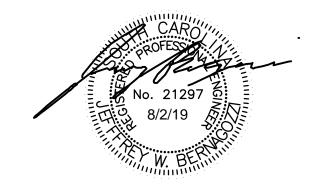

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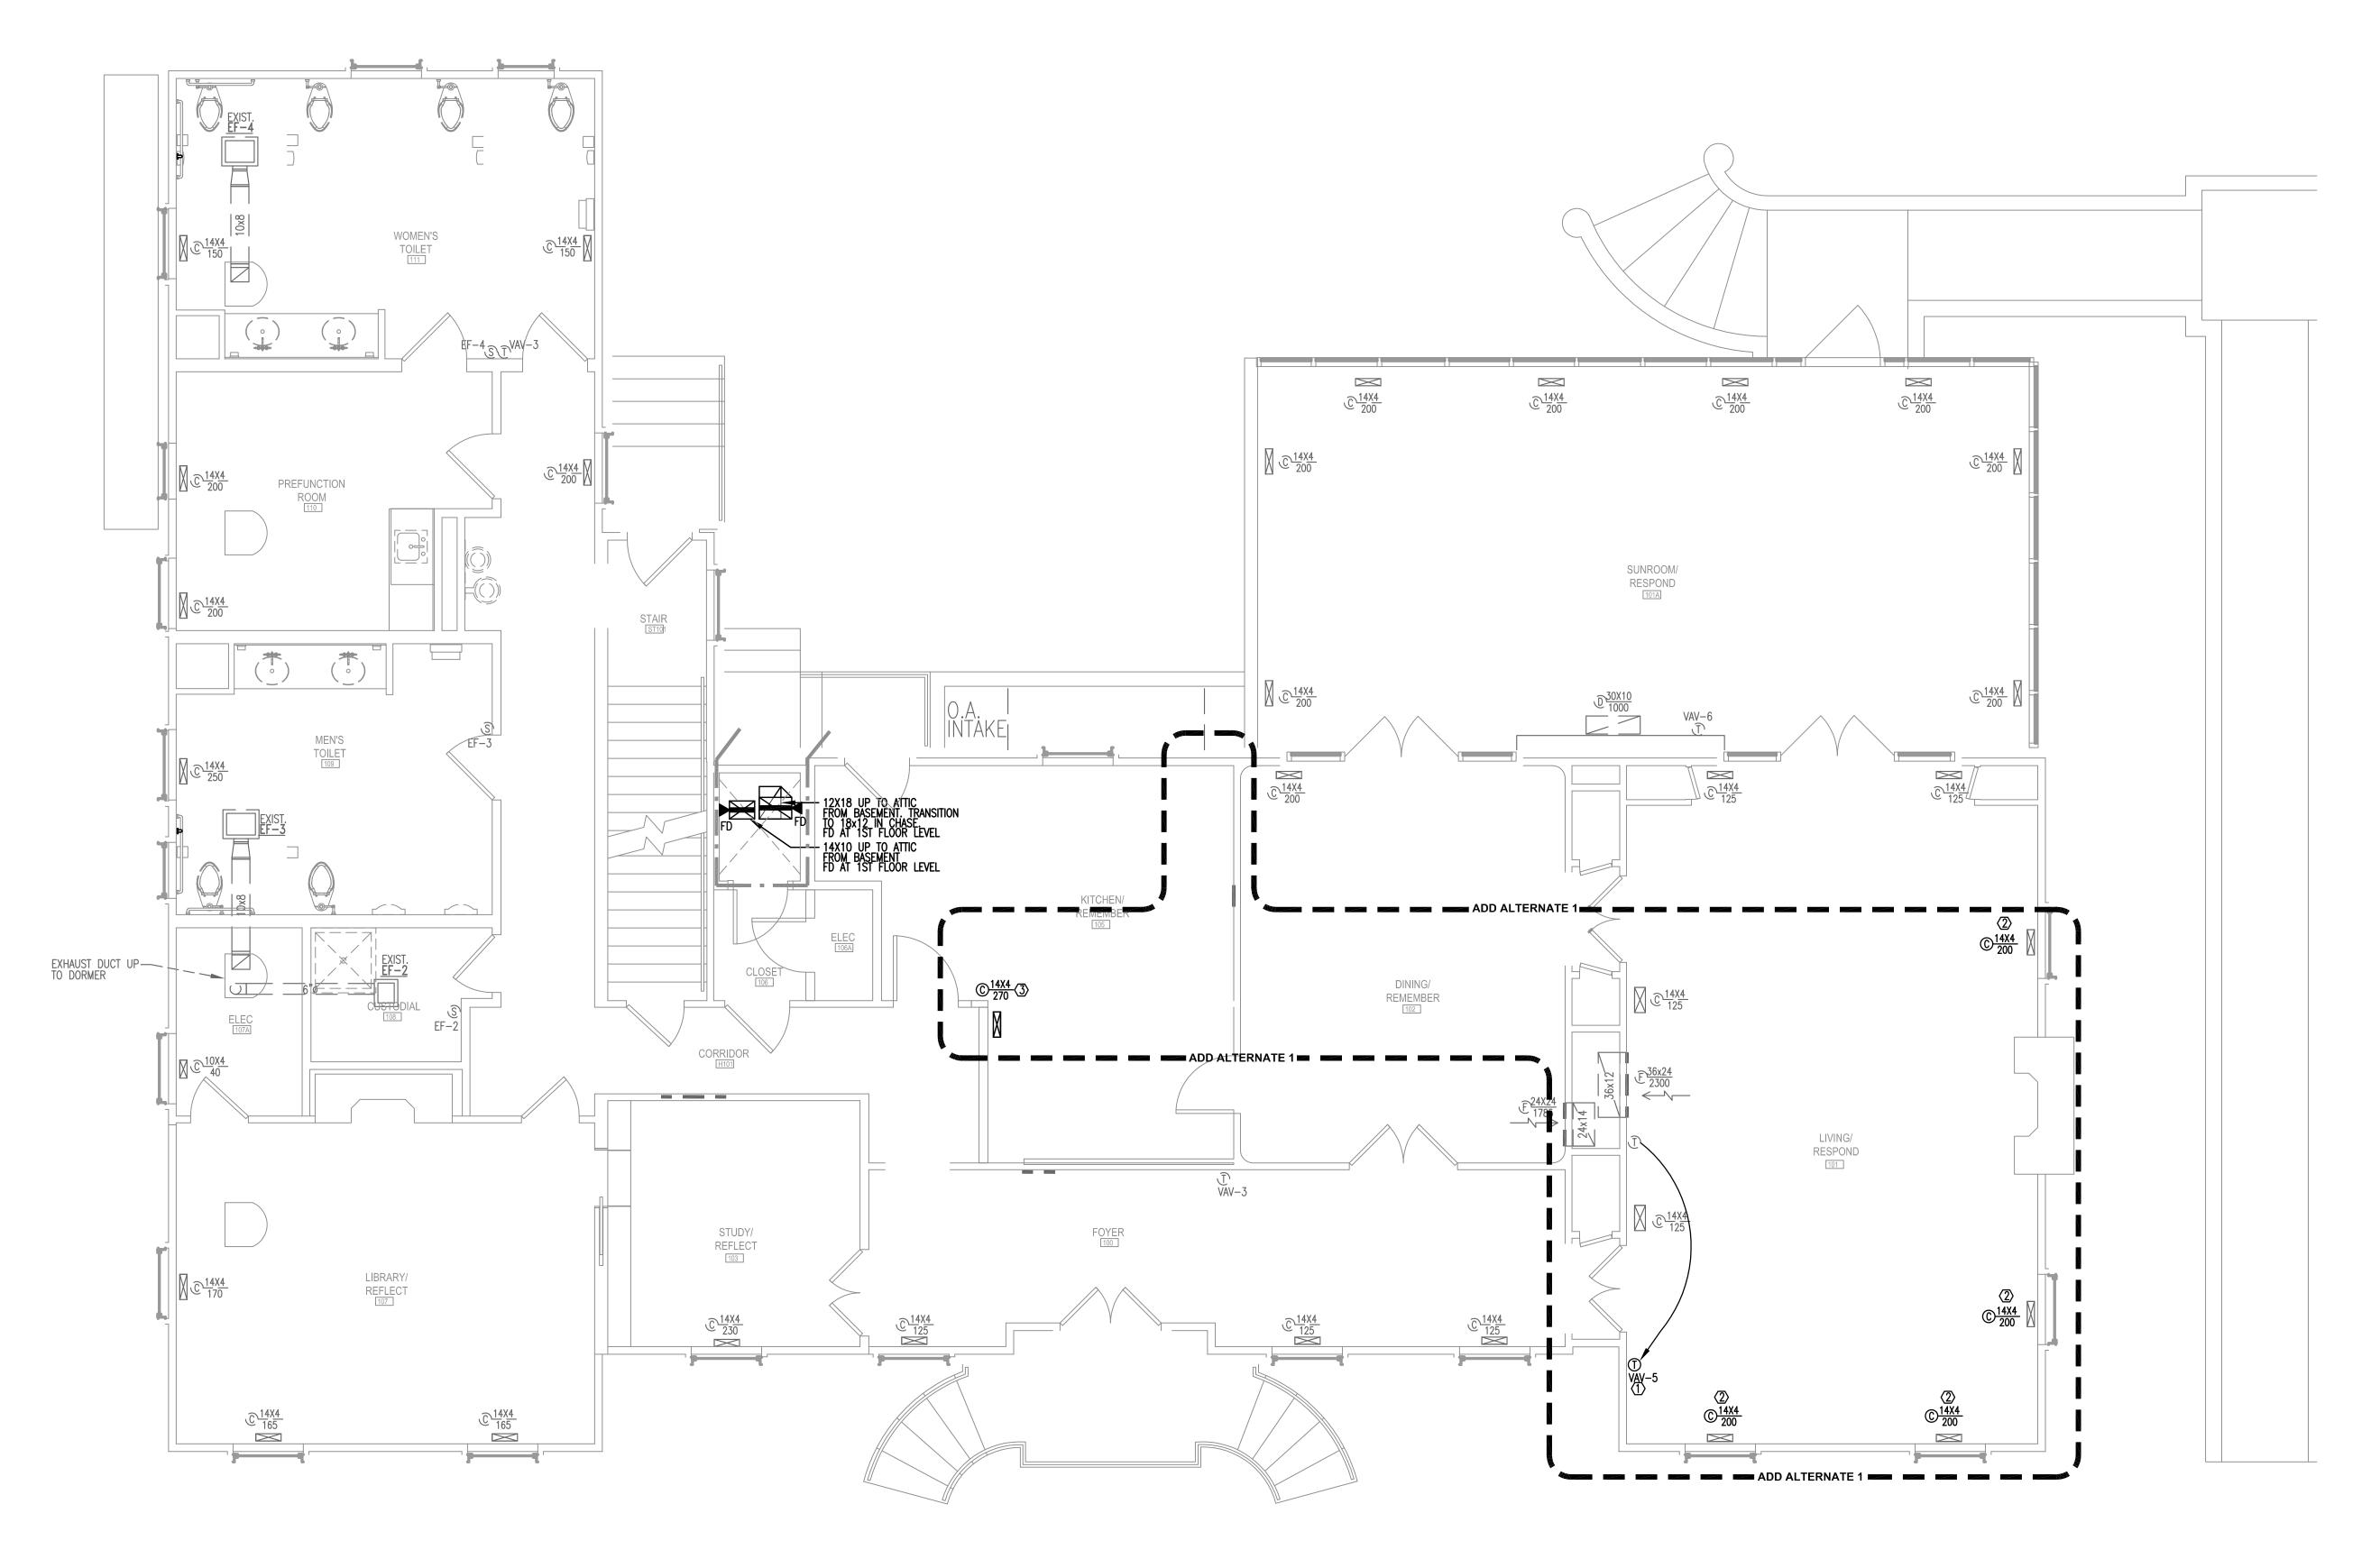


sheet title
HVAC
RENOVATION
BASEMENT PLAN

sheet number

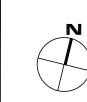M2.0

drawn by JWB
checked by JDR



1) FIRST FLOOR LEVEL - HVAC RENOVATION

RENOVATION KEYNOTES:

(1) RELOCATE EXISTING TEMPERATURE SENSOR TO THIS LOCATION
(2) RE-BALANCE EXISTING SUPPLY GRILLE TO 200 CFM

REQUIRED WORK SEQUENCE: A. Construct Work in stages during construction period: 1. Stage 1: [2nd Floor alterations]. Achieve full certificate of occupancy, including life safety system operational inspection and all other final completion requirements, by October 16, 2019. 2. Stage 2: [1st Floor alterations (if alternate is accepted)].
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project name BARRINGER HOUSE RENOVATIONS

State project number PROJECT # FP00000285 GMK project number PROJECT # 16070.03/H27-D339-ID seals/signature





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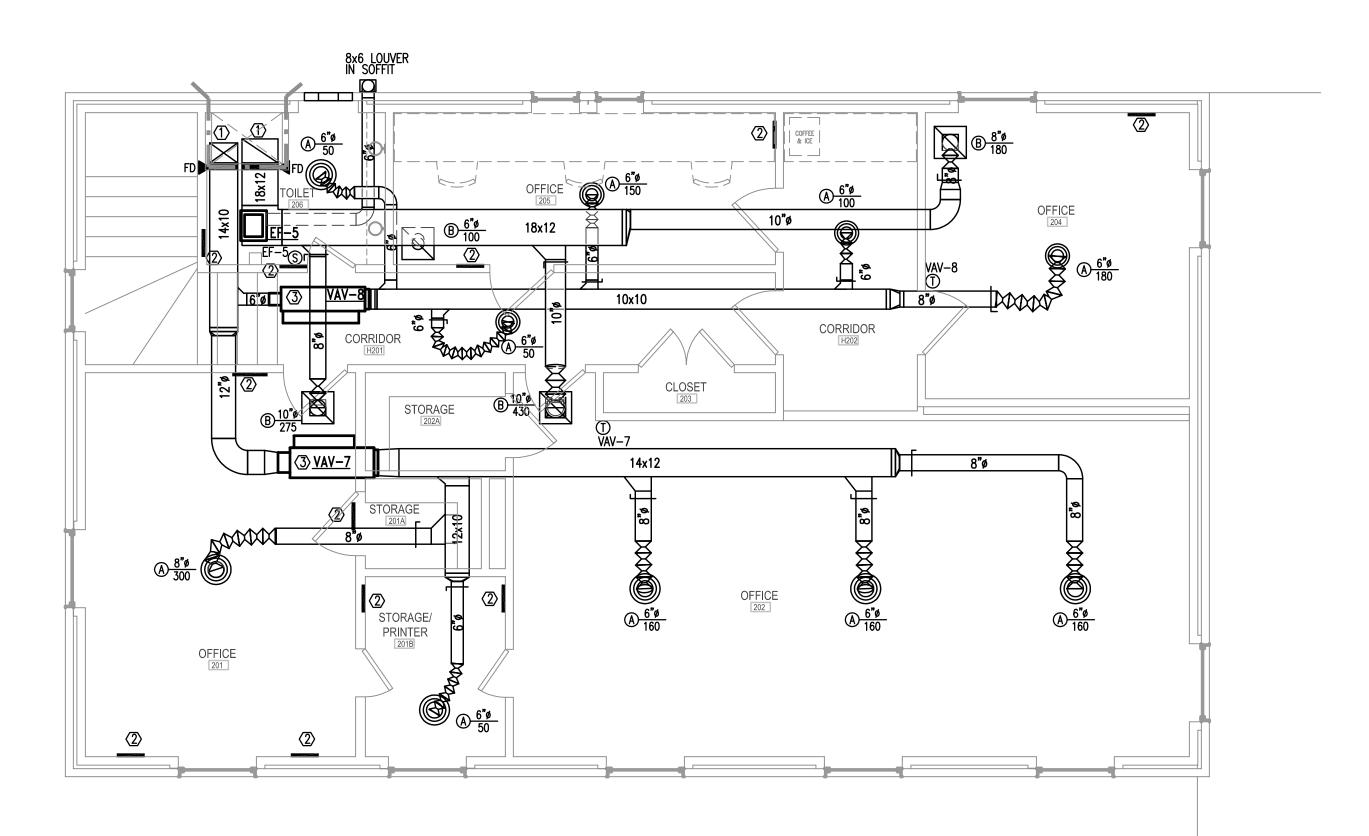
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HVAC **RENOVATION** FIRST FLOOR PLAN

sheet number

drawn by **JWB** checked by JDR



SECOND FLOOR LEVEL - HVAC RENOVATION

1/4"=1'-0"

- RENOVATION KEYNOTES:

 (1) NEW DUCT UP FROM BELOW. INSTALL FIRE DAMPER WHERE DUCTS LEAVE CHASE IN ATTIC.
- (2) EXISTING GRILLE TO BE ABANDONED IN PLACE. CONTRACTOR SHALL CAP DUCT AS NEAR AS POSSIBLE TO GRILLE. IF DUCT IS CAPPED DIRECTLY BEHIND GRILLE FACE. SHEET METAL CAP MUST BE PAINTED BLACK SO AS NOT TO BE
- ③ VAV BOXES SHALL BE OWNER FURNISHED AND CONTRACTOR INSTALLED

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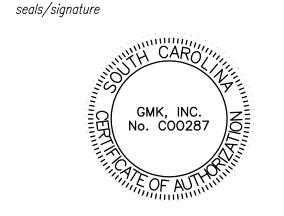
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USC CAMPUS PLANNING AND CONSTRUCTION 1300 PICKENS STREET COLUMBIA, SOUTH CAROLINA 29208

project name BARRINGER HOUSE RENOVATIONS

State project number PROJECT # FP00000285 GMK project number PROJECT # 16070.03/H27-D339-ID





CONSTRUCTION DOCUMENTS

^{date} AUGUST 2, 2019

number	item	date

key plan



HVAC **RENOVATION** SECOND FLOOR PLAN

sheet number


drawn by JWB checked by JDR

REQUIRED WORK SEQUENCE:

A. Construct Work in stages during construction period:

1. Stage 1: [2nd Floor alterations]. Achieve full certificate of occupancy, including life safety system operational inspection and all other final completion requirements, by October 16, 2019. 2. Stage 2: [1st Floor alterations (if alternate is accepted)].
Achieve full certificate of occupancy, including life safety system operational inspection and all final completion

requirements, within 105 calendar days from the Date of Commencement. B. Coordinate construction schedule and operations with Owner.
C. Work on the 1st floor that supports the Work on the 2nd floor functionally (such as ducts, shafts, vertical piping and infrastructure, etc.) is to be included in Stage 1 work.

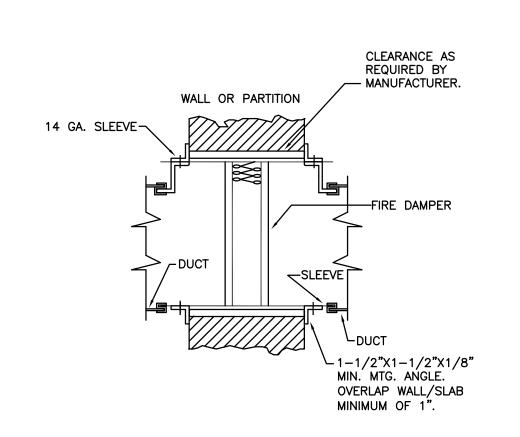


1. PROVIDE TYPE "C" DYNAMIC FIRE DAMPERS IN ALL 1 HR. THRU 4 HR. WALLS, SLABS, AND PARTITIONS SHOWN ON ARCH. AND MECH. DRAWINGS. 2. PROVIDE DUCT ACCESS DOOR. ACCESS DOOR SHALL BE LARGE ENOUGH TO PERMIT INSPECTION AND MAINTENANCE OF THE DAMPER AND ITS OPERATING PARTS. ACCESS DOOR SHALL BE LABELED "FIRE DAMPER". THE LETTERS SHALL NOT BE LESS THAN 0.5 INCHES IN HEIGHT.


3. PROVIDE ALL CEILING, FLOOR, AND WALL ACCESS DOORS NECESSARY FOR ACCESS TO FIRE DAMPER. 4. FIRE DAMPERS SHALL COMPLY WITH THE REQUIREMENTS OF UL 555 AND INSTALLED IN ACCORDANCE WITH MANUFACTURER'S RECOMMENDATIONS. ONLY FIRE DAMPERS LABELED FOR USE IN DYNAMIC SYSTEMS SHALL BE INSTALLED IN HEATING, VENTILATION AND AIR—CONDITIONING SYSTEMS DESIGNED TO OPERATE WITH FANS ON DURING A FIRE.


5. BLANKET INSULATION SHALL BE INSTALLED OVER ANGELS AND SEALED TO WALL. 6. DAMPER BLADES SHALL BE LOCATED OUT OF THE


7 VERTICAL FIRE DAMPER DETAIL NTS

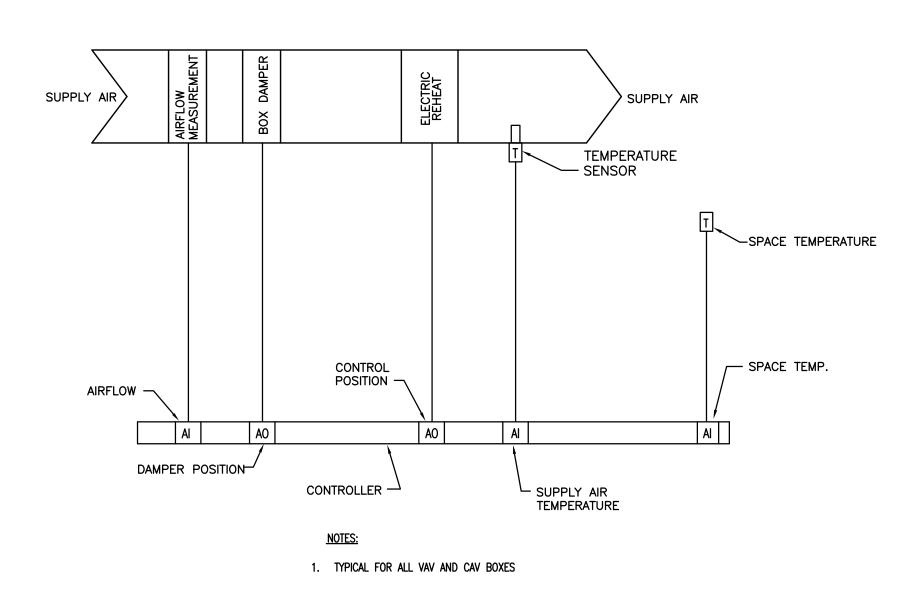


4 TERMINAL BOX CONTROL DIAGRAM

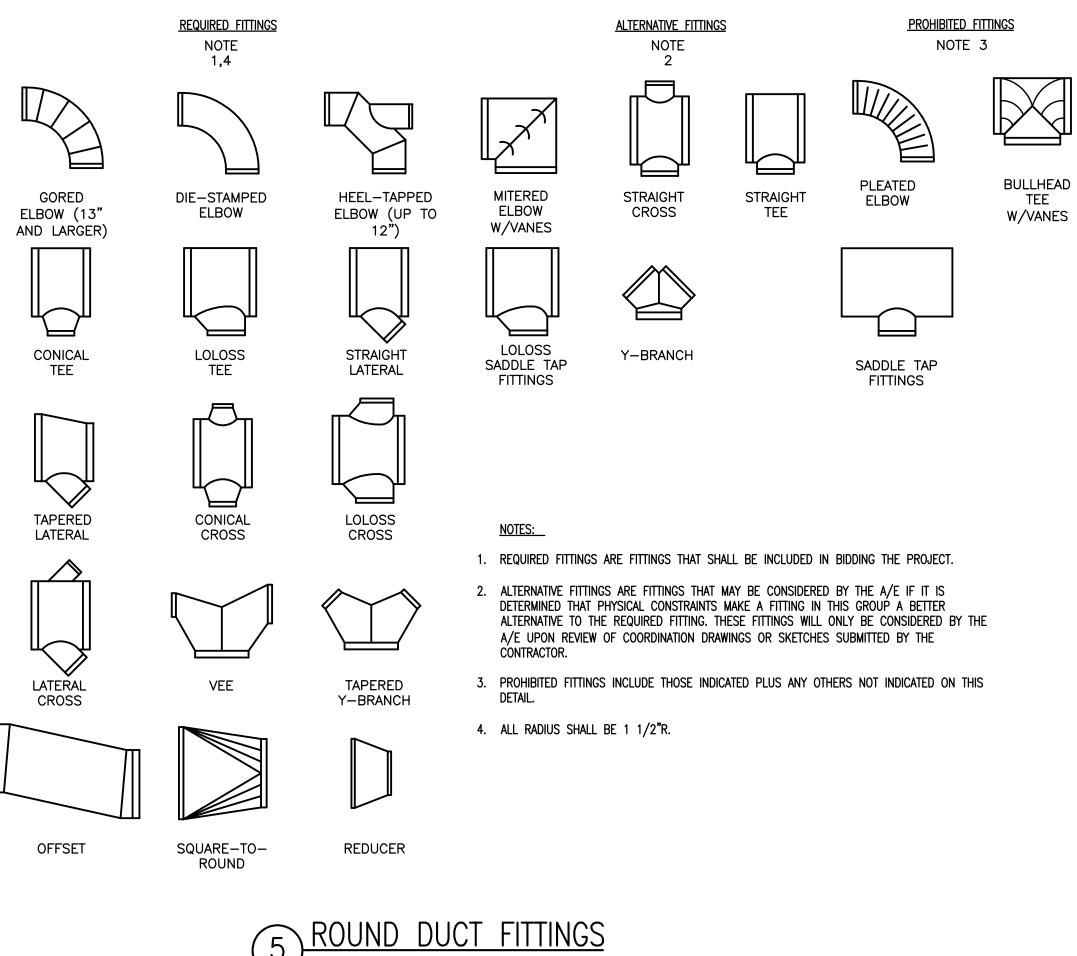


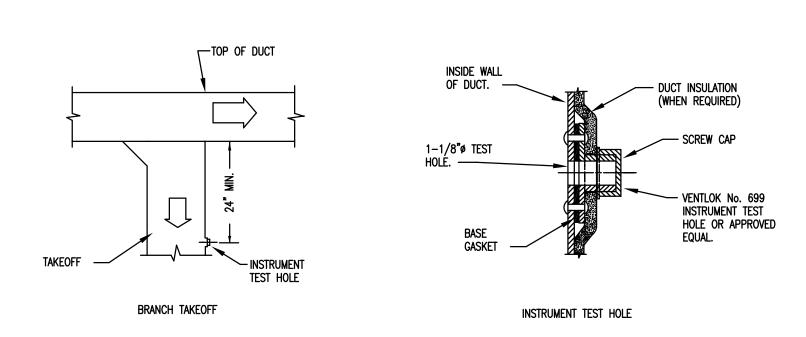

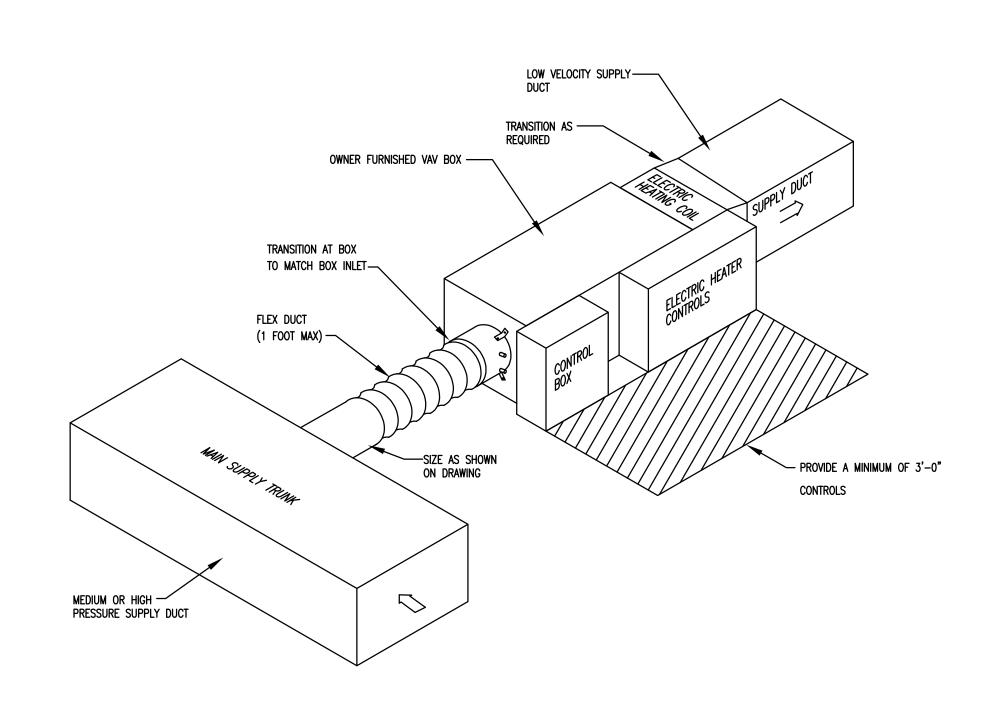

1) SHUT OFF TYPE VAV OR CAV DETAIL

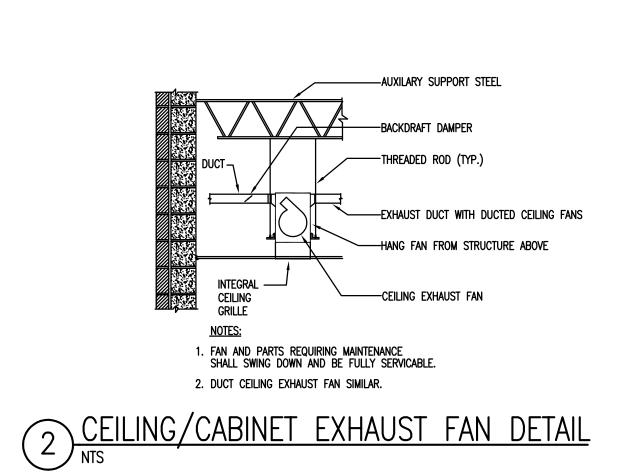

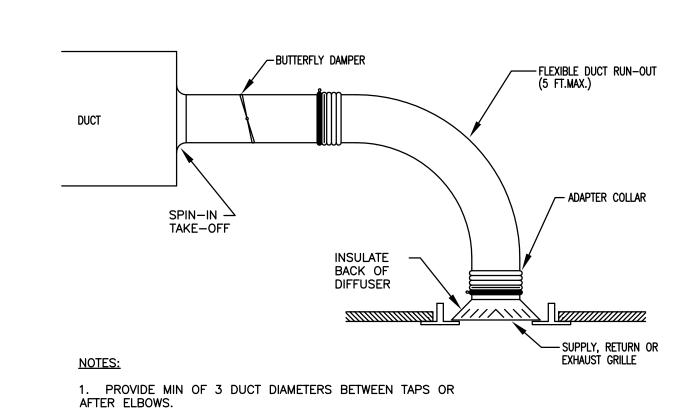





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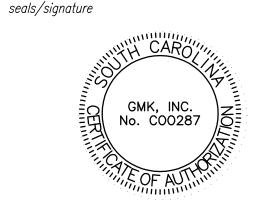
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USC CAMPUS PLANNING AND CONSTRUCTION 1300 PICKENS STREET COLUMBIA, SOUTH CAROLINA 29208

project name BARRINGER HOUSE RENOVATIONS

State project number PROJECT # FP00000285 GMK project number PROJECT # 16070.03/H27-D339-ID






CONSTRUCTION DOCUMENTS

AUGUST 2, 2019

number	item	date

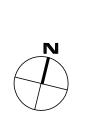

sheet title
HVAC
DETAILS

sheet number

checked by JDR

HVAC	LEGEND
\boxtimes	Supply diffuser
	return / exhaust
FD.	FIRE DAMPER IN FIRE—RATED WALL
T	THERMOSTAT
•	CONNECT TO EXISTING
CHWS	CHILLED WATER SUPPLY
CHWR	CHILLED WATER RETURN
	FLEXIBLE DUCT
R P	CHANGE IN DUCT ELEVATION
	DUCT TURNING DOWN
	DUCT TURNING UP
吳	2-WAY CONTROL VALVE
\text{\displays } \disp	3-WAY CONTROL VALVE
	NECK SIZE
DIFFUSER, GRILLE, LOUVE OR REGISTER TYPE	ER——(A) 6"ǿ 100
	∼PEAK LOAD CFM

►PEAK LOAD CFM

MECHANICAL DEMOLITION NOTES

- DRAWINGS SHOW GENERAL INTENT OF DEMOLITION. QUANTITIES, LOCATIONS, SIZES AND EQUIPMENT ARE SHOWN TO INDICATE TYPE OF SYSTEM INSTALLED AND DOES NOT NECESSARILY REPRESENT EXACT CONDITIONS. CONTRACTOR SHALL FIELD VERIFY BEFORE BIDDING.
- 2. DEMOLITION OF EQUIPMENT, SYSTEMS, AND COMPONENTS SHALL INCLUDE ALL SUPPORTS, PADS, HANGERS, INSULATION, CONTROLS, STARTERS, ACCESSORIES, AND APPURTENANCES NOT REQUIRED FOR THE INSTALLATION OF THE NEW SYSTEM.
- 3. WHEN PARTIAL DEMOLITION OF A SYSTEM IS INDICATED, THE PART OF THE SYSTEM SHOWN TO REMOVED SHALL BE REMOVED TO THE ACTIVE MAIN OR BRANCH IF NOT REQUIRED FOR THE INSTALLATION OF THE NEW SYSTEM. THE ACTIVE MAIN OR BRANCH SHALL BE REPAIRED TO MATCH NEW INSTALLATION AS MUCH AS PRACTICAL. IF SYSTEM IS INSULATED, INSULATION SHALL BE PATCHED AND FINISHED REPAIR (IE: VAPOR BARRIER, COATING, ETC.)
- 4. PATCHING OF BUILDING STRUCTURES AND FINISHES SHALL PERTAIN TO ALL WALLS, FLOORS, SLABS, ROOFS, STRUCTURES, AND FINISHES. PATCHES SHALL MATCH EXISTING STRUCTURE, FIRE RATING AND FINISH.
- 5. ALL OPENINGS CREATED BY THE ABANDONMENT OR REMOVAL OF EXISTING SYSTEMS SHALL BE PATCHED.
- 6. ALL WALLS, ROOFS, SLABS, STRUCTURES, AND FINISHES WHOSE FINISH IS IRREGULAR DUE TO THE REMOVAL OF SYSTEMS, SUPPORTS, PADS, ACCESSORIES, AND APPURTENANCES SHALL BE PATCHED.

7. ALL FINISHES SHALL MATCH EXISTING FINISH. WHEN FINISH

- OBVIOUSLY DOES NOT MATCH EXISTING FINISH SUCH AS SHADE OF PAINT, AGE OF FINISH, ETC., THE FINISH SHALL BE APPLIED TO THE PATCH AND THE SURFACE IN ALL DIRECTIONS UNTIL A SURFACE CHANGE OF A MINIMUM OF 45 DEGREES.
- . REMOVAL OF SYSTEMS SHALL INCLUDE COMPLETE SYSTEM WHENEVER PRACTICAL. IF NOT, SYSTEM (IE: PIPE, CONDUIT, ETC.) SHALL BE REMOVED TO 1 INCH BELOW SURFACE.

MECHANICAL GENERAL NOTES

- DO NOT SCALE DRAWINGS; SEE ARCHITECTURAL DRAWINGS AND REFLECTED CEILING PLANS FOR EXACT LOCATIONS OF
- DOORS, WINDOWS, CEILING DIFFUSERS, ETC. LOCATE ALL THERMOSTATS, HUMIDISTATS AND SWITCHES 4'-0" ABOVE FINISH FLOOR; ALIGN WITH LIGHT SWITCHES. DUCTWORK LOCATIONS SHALL BE COORDINATED WITH THE WORK UNDER OTHER DIVISIONS OF THE SPECIFICATIONS TO
- 4. CORRECT SETTINGS ON ALL BALANCING FITTINGS SHALL BE PERMANENTLY MARKED. 5. RUNOUTS SHALL PITCH DOWN IN DIRECTION OF FLOW A
- MINIMUM OF 1" IN 30 FEET. 6. AIR DISTRIBUTION SYSTEMS WITH MORE THAN ONE BRANCH, OR MULTIPLE OUTLETS ON A BRANCH, SHALL HAVE VOLUME DAMPERS TO BALANCE AIR FLOWS. SPIN-IN FITTINGS ARE PERMITTED FOR CONNECTING FLEX DUCT TO BRANCH OR TRUNK DUCTS WHERE FLEX DUCTS ARE INDICATED. IF FLEX DUCT CANNOT BE CONNECTED WITH A
- SPIN-IN, A HARD DUCTED TAKEOFF MUST BE PROVIDED. 7. 45 DEGREE TAKEOFFS SHALL BE USED ON ALL HARD DUCTED SUPPLY BRANCHES.
- PROVIDE ALL TRANSITIONS REQUIRED FOR INSTALLATION OF DUCT, DUCT HEATERS, AIR VOLUME CONTROLLERS, FAN COIL UNITS, EXHAUST FANS, SUPPLY FANS, AND ALL OTHER EQUIPMENT AND APPURTENANCES. 9. BLANK-OFF ALL UNUSED PORTIONS OF LOUVERS (WHICH
- HAVE MECHANICAL DUCT CONNECTIONS) WITH 20 GAGE GALVANIZED SHEET METAL. 10. ALL DUCT IS GALVANIZED SHEET METAL EXCEPT AS NOTED.
- 11. DUCT SIZES ARE CLEAR INSIDE DIMENSIONS. 12. INTAKES FOR AIR HANDLING EQUIPMENT SHALL BE A
- MINIMUM OF TEN FEET AWAY FROM ANY EXHAUST OR 13. AIR DISTRIBUTION UNITS SHALL HAVE TRIM REQUIRED FOR
- FINISHED SERVICE. 14. COORDINATE ORIENTATION OF SUPPLY AND RETURN PIPING BEFORE FABRICATION.
- 15. PROVIDE DIELECTRIC FITTINGS AT ALL LOCATIONS WHERE DISSIMILAR METALS ARE JOINED IN PIPING AND DUCT
- 16. ALL SUPPLY AND RETURN DUCTS SHALL HAVE TURNING

VARIABLE A	AIR	VOLUME	TERMINAL	SCHEDULE	(OWNER	FURNISHED)
------------	-----	--------	----------	----------	--------	------------

TAG NO.			MINIMUM		MIN. INLET		REHEAT CO	L	INLET SIZE	ELECTRICAL	MANUFACTURER	MODEL NO.	NOTE
170 110.	BOX CFM	BOX CFM	S.P. (W.C.)	LAT	KW	STAGES		WANTONATONEN	WODEL NO.	NOTE			
EXIST. VAV-5	1700	550							TRANE	VCEF12	2		
VAV-7	830	400	1"	90°	5	2	10"	208/3	TRANE	VCEF10	1,4,5		
VAV-8	530	300	1"	86	3	1	6"	208/3	TRANE	VCEF06	1,4,5		

1. ELECTRIC ACTUATOR 4. SINGLE POINT POWER CONNECTION WITH DISCONNECT 2. RE-BALANCE EXST. BOX CFM'S 5. ACCESS PANEL 3. SOUND ATTENUATOR

			EXH <i>A</i>	AUS	ST :	FAN SC	HEDULE		
TAG	TYPE	CAPACITY CFM	E.S.P. (IN. WG.)	MO WATTS	TOR RPM	ELECTRICAL (VOLTS/PHASE)	MANUFACTURER	MODEL NO.	NOTES
EF-5	CEILING	50	.375	128	636	115/1	GREENHECK	SP-150	2,3,8,9,10
	BACKDRAFT DAMPER CKDRAFT DAMPER T SWITCH		EN I ROOF CURB E FAN GUARD	8.	FILTER RHEOSTAT WALL SWIT		Ξ 3		

		A	AIR]	DISTI	RIBUT	ION SCH	HEDULE		
TAG	DESCRIPTION	NECK	MODULE SIZE	MOUNT	CONSTR.	MFGR	MODEL	NOTES	
A	ROUND ADJUSTABLE	AS SHOWN		SURFACE	ALUMINUM	HART AND COOLEY	SERIES 20	2,3,4	
В	PERFORATED CEILING RETURN/EXHAUST	AS SHOWN	12x12	SURFACE	ALUMINUM	PRICE	SERIES APDDR	3,5	
1. F 2. 4	TURNISH WITH OPPOSED BLADE DAMPER 4-WAY DEFLECTION UNLESS NOTED OTHER	3. BA RWISE 4. FIN	KED ENAME IISH SELECT	L OFF-WHITI TED BY ARCI	E FINISH HITECT		_		

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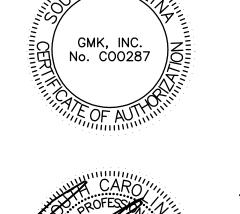
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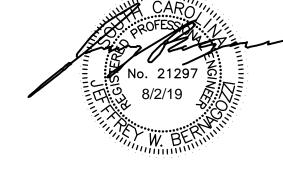
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USC CAMPUS PLANNING AND CONSTRUCTION 1300 PICKENS STREET COLUMBIA, SOUTH CAROLINA 29208

project name BARRINGER HOUSE RENOVATIONS

State project number PROJECT # FP00000285 GMK project number PROJECT # 16070.03/H27-D339-ID seals/signature






CONSTRUCTION DOCUMENTS

^{date} AUGUST 2, 2019

number	item	date



NOTES & SCHEDULES

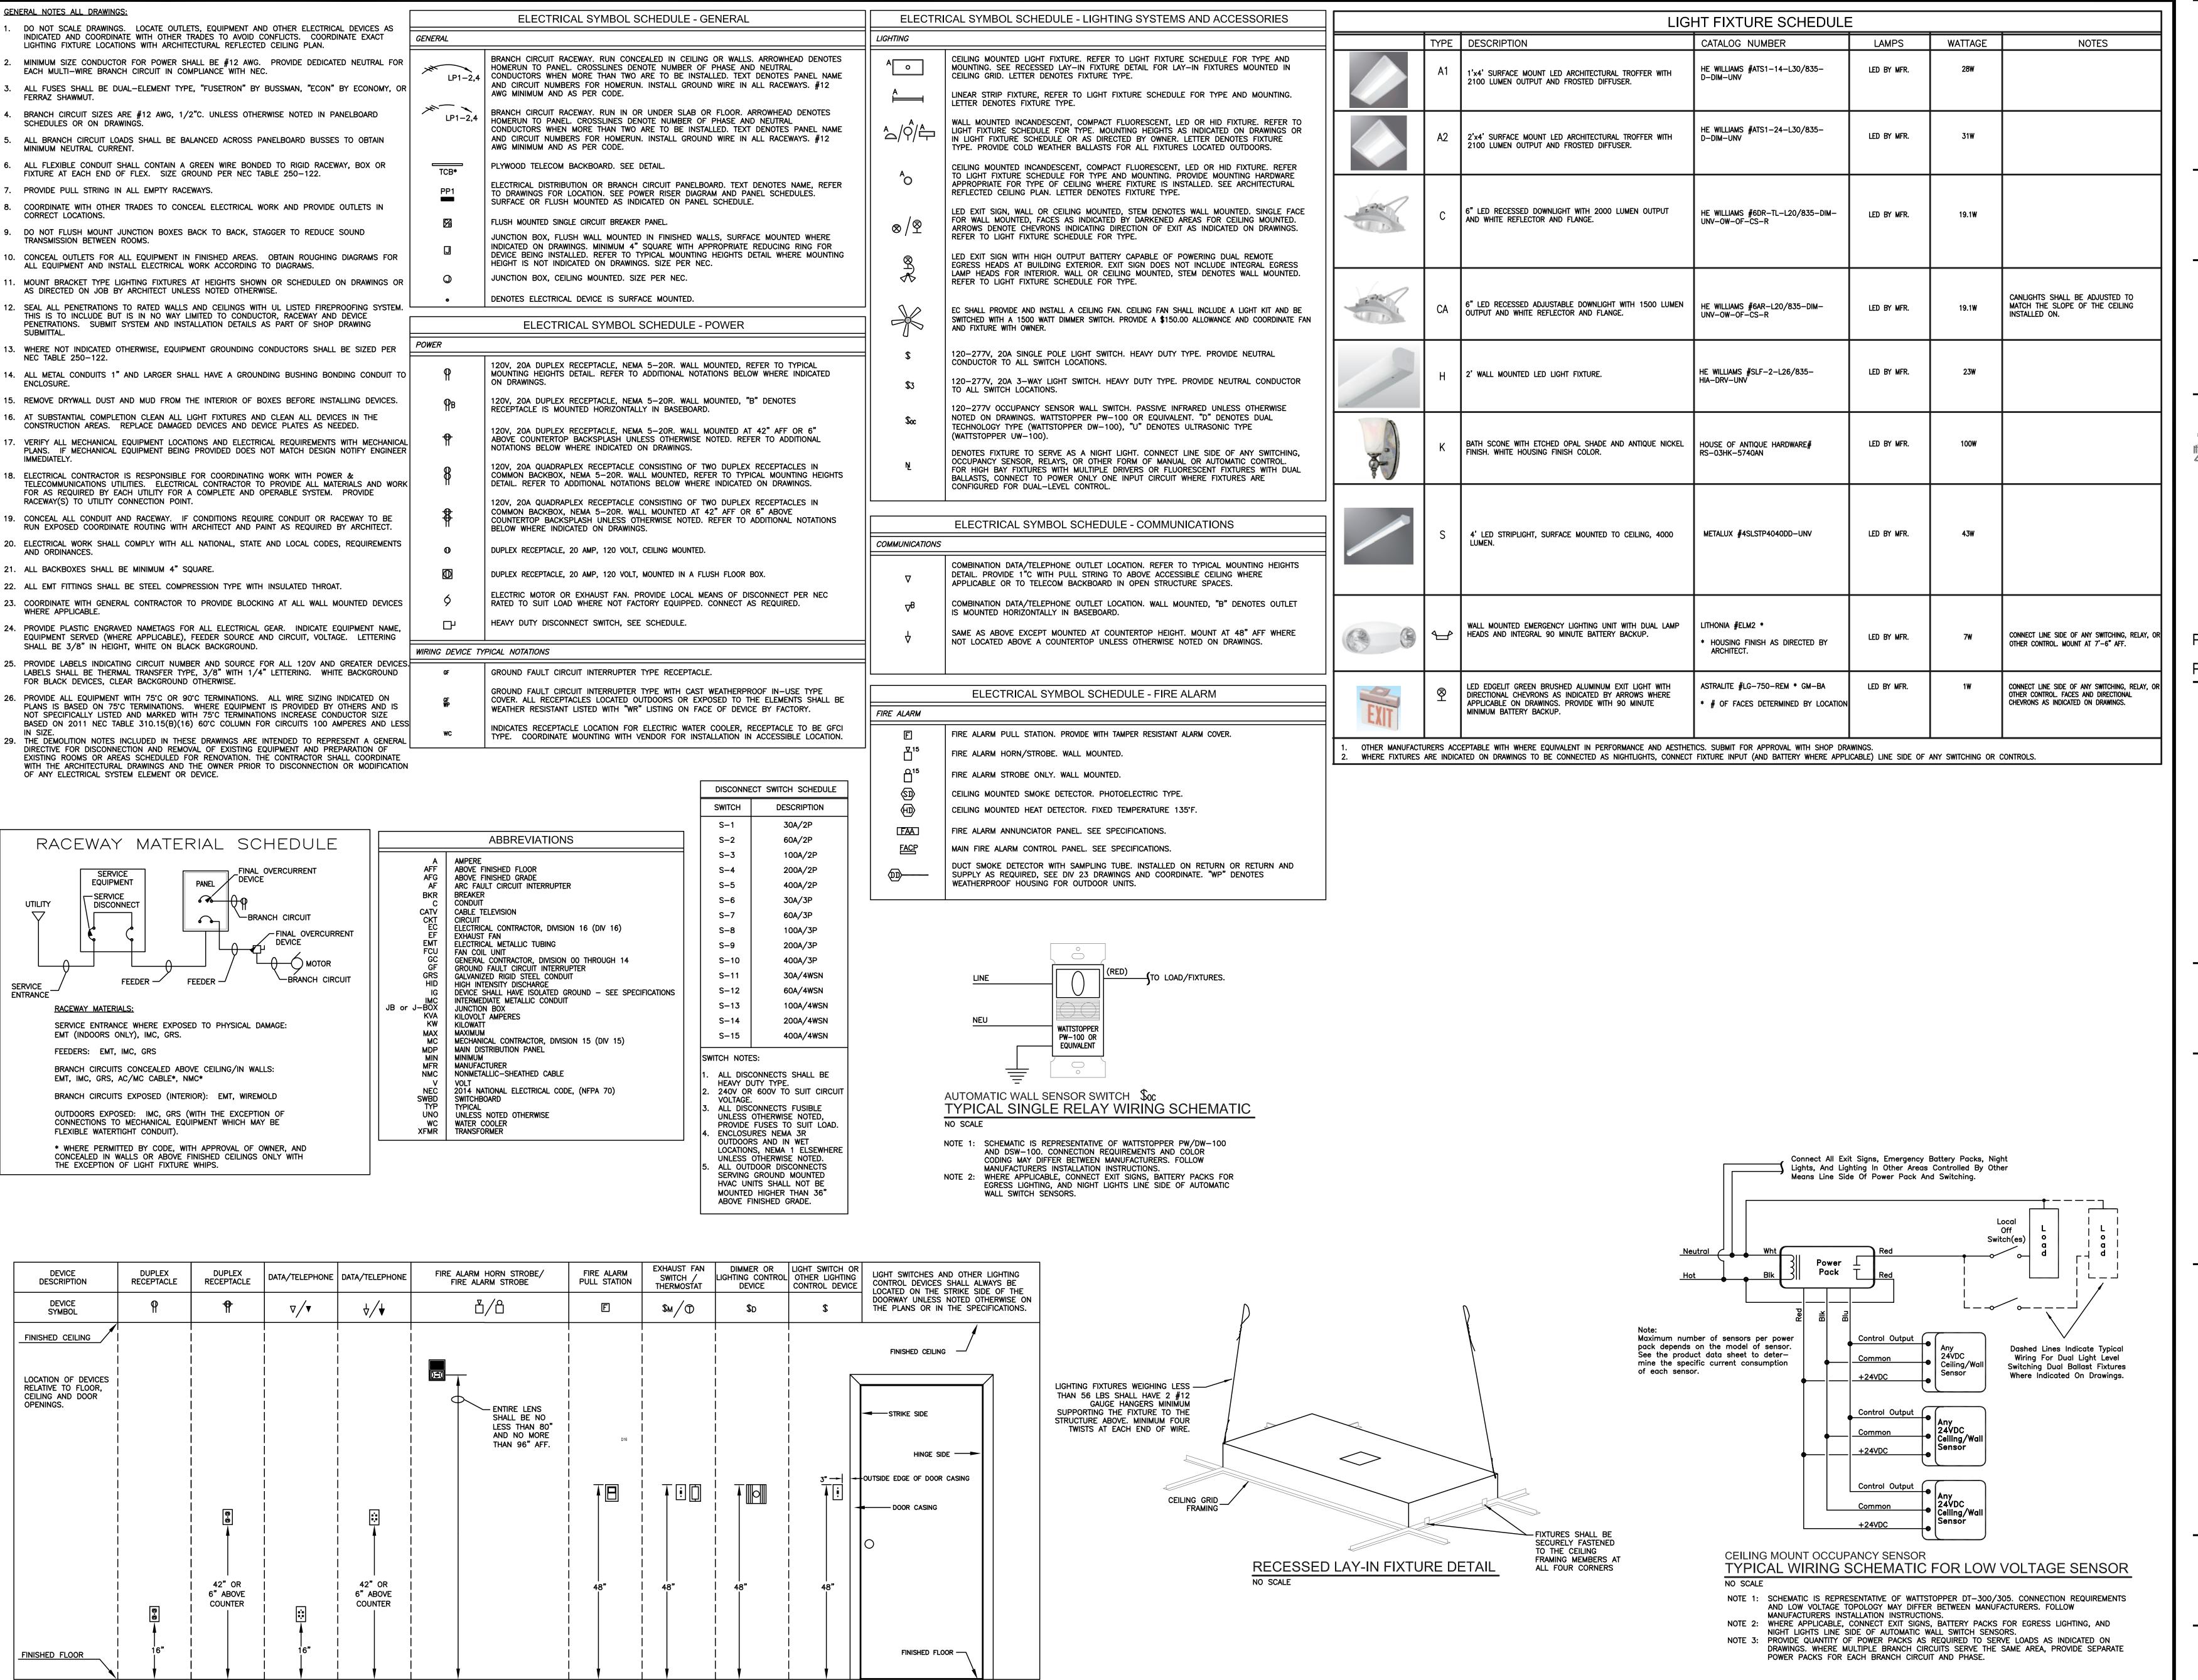

*****ALL MOUNTING HEIGHTS ARE TYPICAL UNLESS OTHERWISE NOTED ON PLANS.****

DEVICE MOUNTING HEIGHTS

NO SCALE

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Owner

UNIVERSITY

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USC CAMPUS PLANNING AND
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1300 PICKENS STREET
COLUMBIA, SOUTH CAROLINA 29208

project name
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RENOVATIONS

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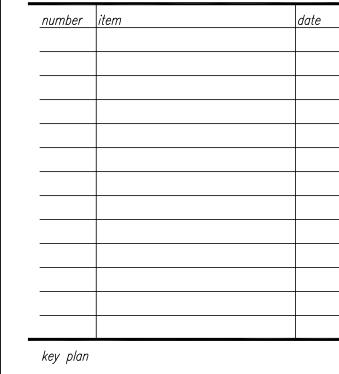
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CONSTRUCTION DOCUMENTS

AUGUST 2, 2019




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ELECTRICAL SYMBOLS, SCHEDULES & DETAILS

sheet number

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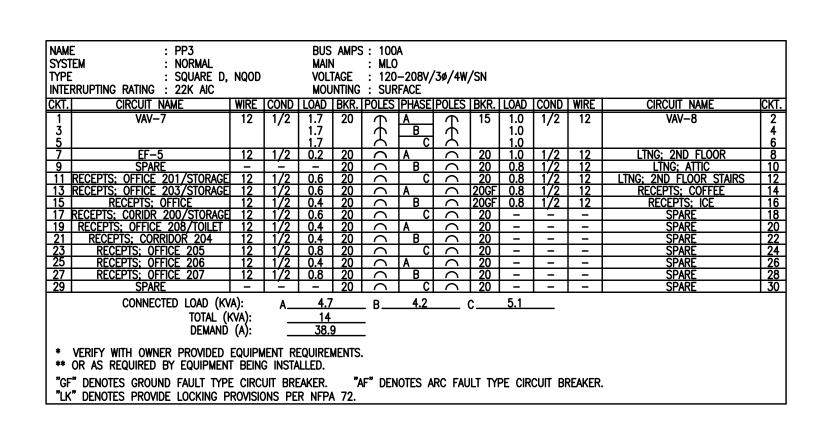
drawn by RMI checked by RMI





POWER RISER DIAGRAM

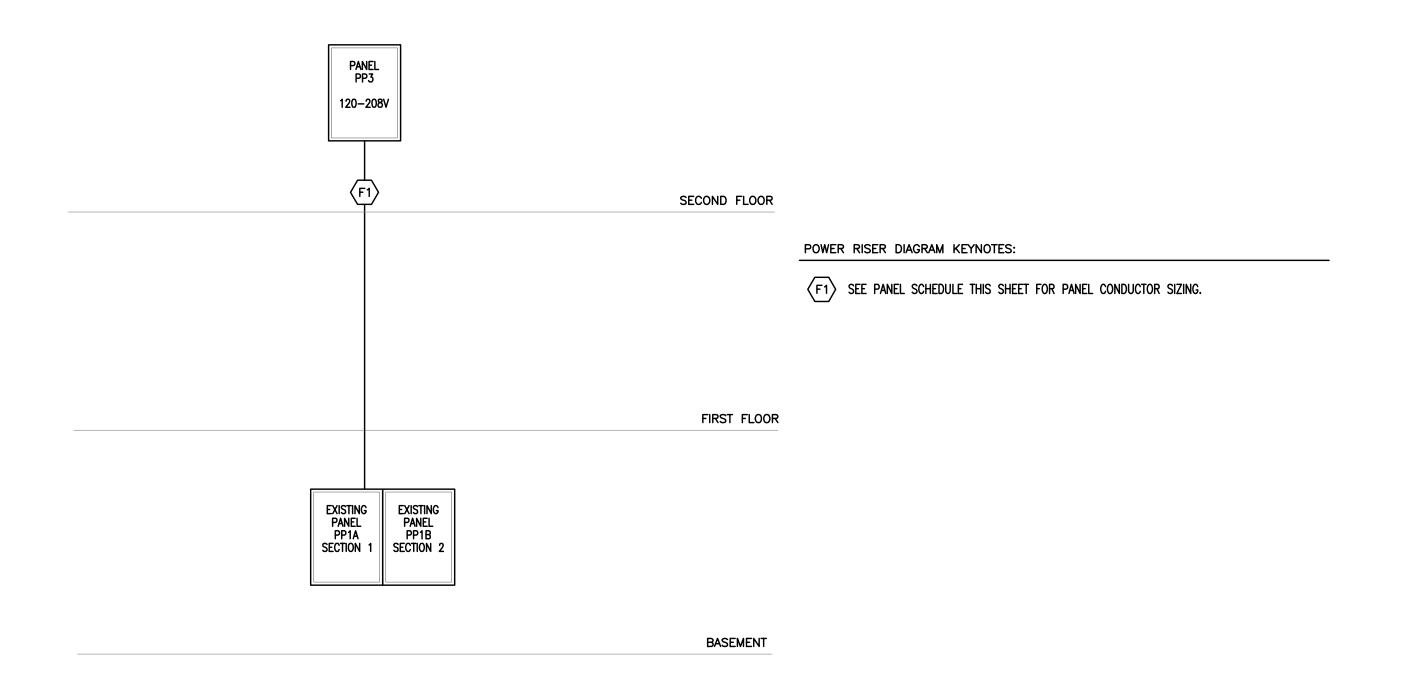"GF" DENOTES GROUND FAULT TYPE CIRCUIT BREAKER.

NO SCALE



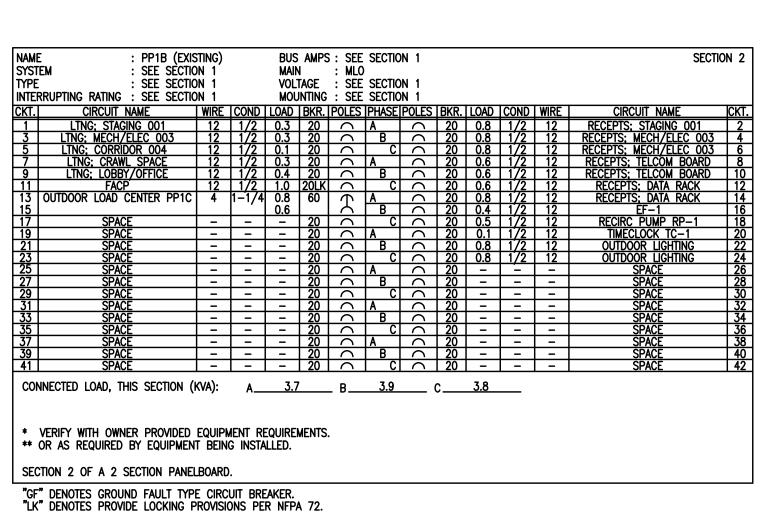

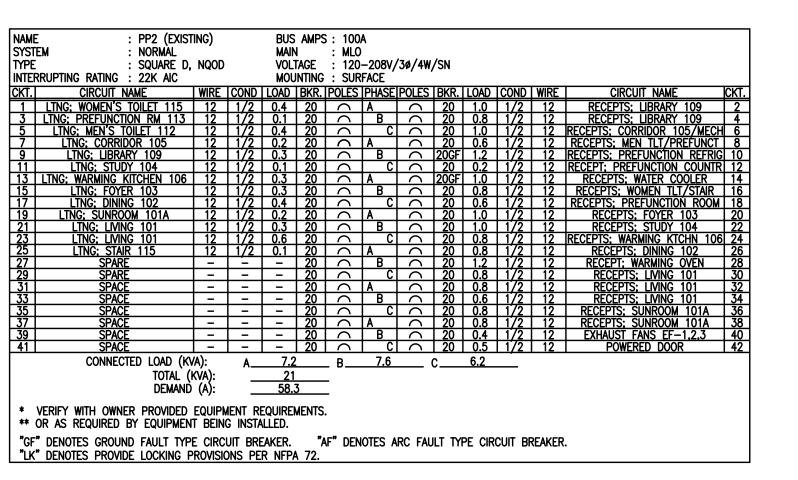

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seals/signature





CONSTRUCTION DOCUMENTS

AUGUST 2, 2019

number	item	dat

key plan



REQUIRED WORK SEQUENCE:

Commencement.

A. Construct Work in stages during construction period:

1. Stage 1: [2nd Floor alterations]. Achieve full certificate of occupancy, including life safety system operational

2. Stage 2: [1st Floor alterations (if alternate is accepted)].
Achieve full certificate of occupancy, including life safety system operational inspection and all final completion

B. Coordinate construction schedule and operations with Owner.
C. Work on the 1st floor that supports the Work on the 2nd floor functionally (such as ducts, shafts, vertical piping and infrastructure, etc.) is to be included in Stage 1 work.

inspection and all other final completion requirements, by October 16, 2019.


réquirements, within 105 calendar days from the Date of

ELECTRICAL PANEL SCHEDULES & RISER DIAGRAMS


sheet number

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drawn by RMI checked by RMI

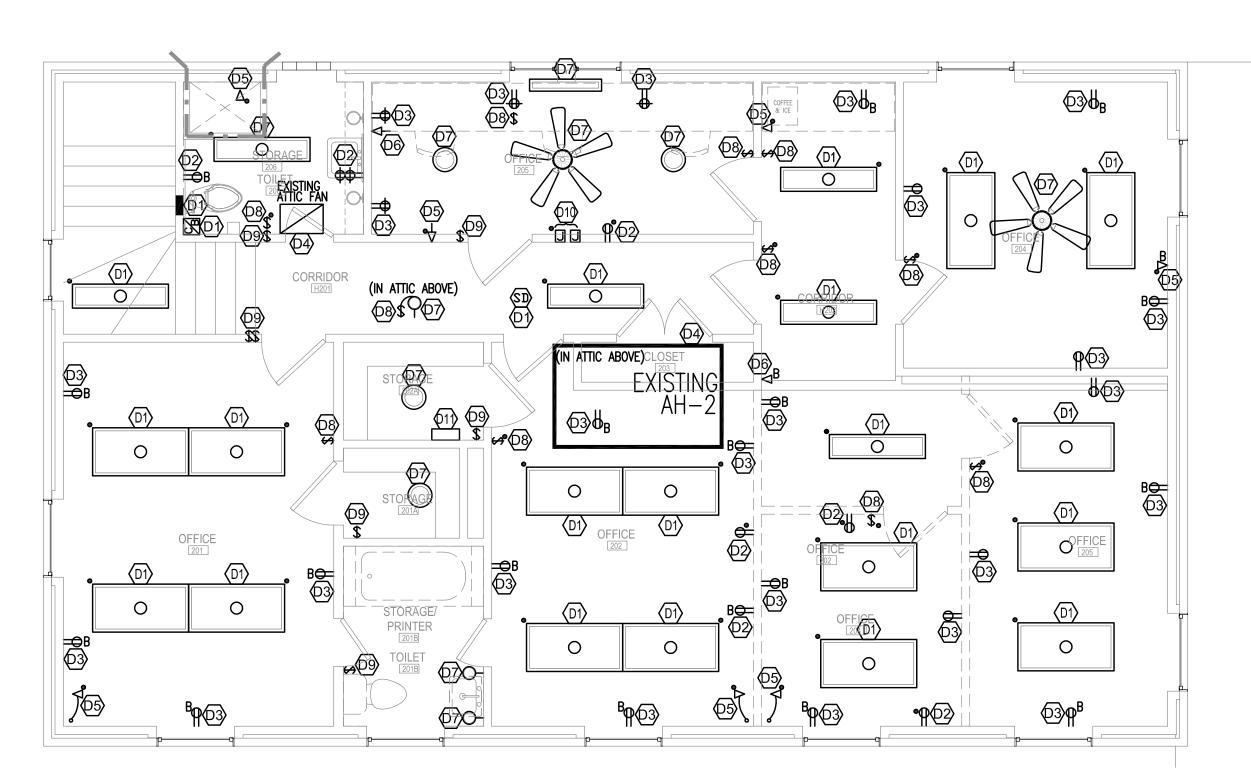

2 SECOND FLOOR - ELEC DEMOLITION

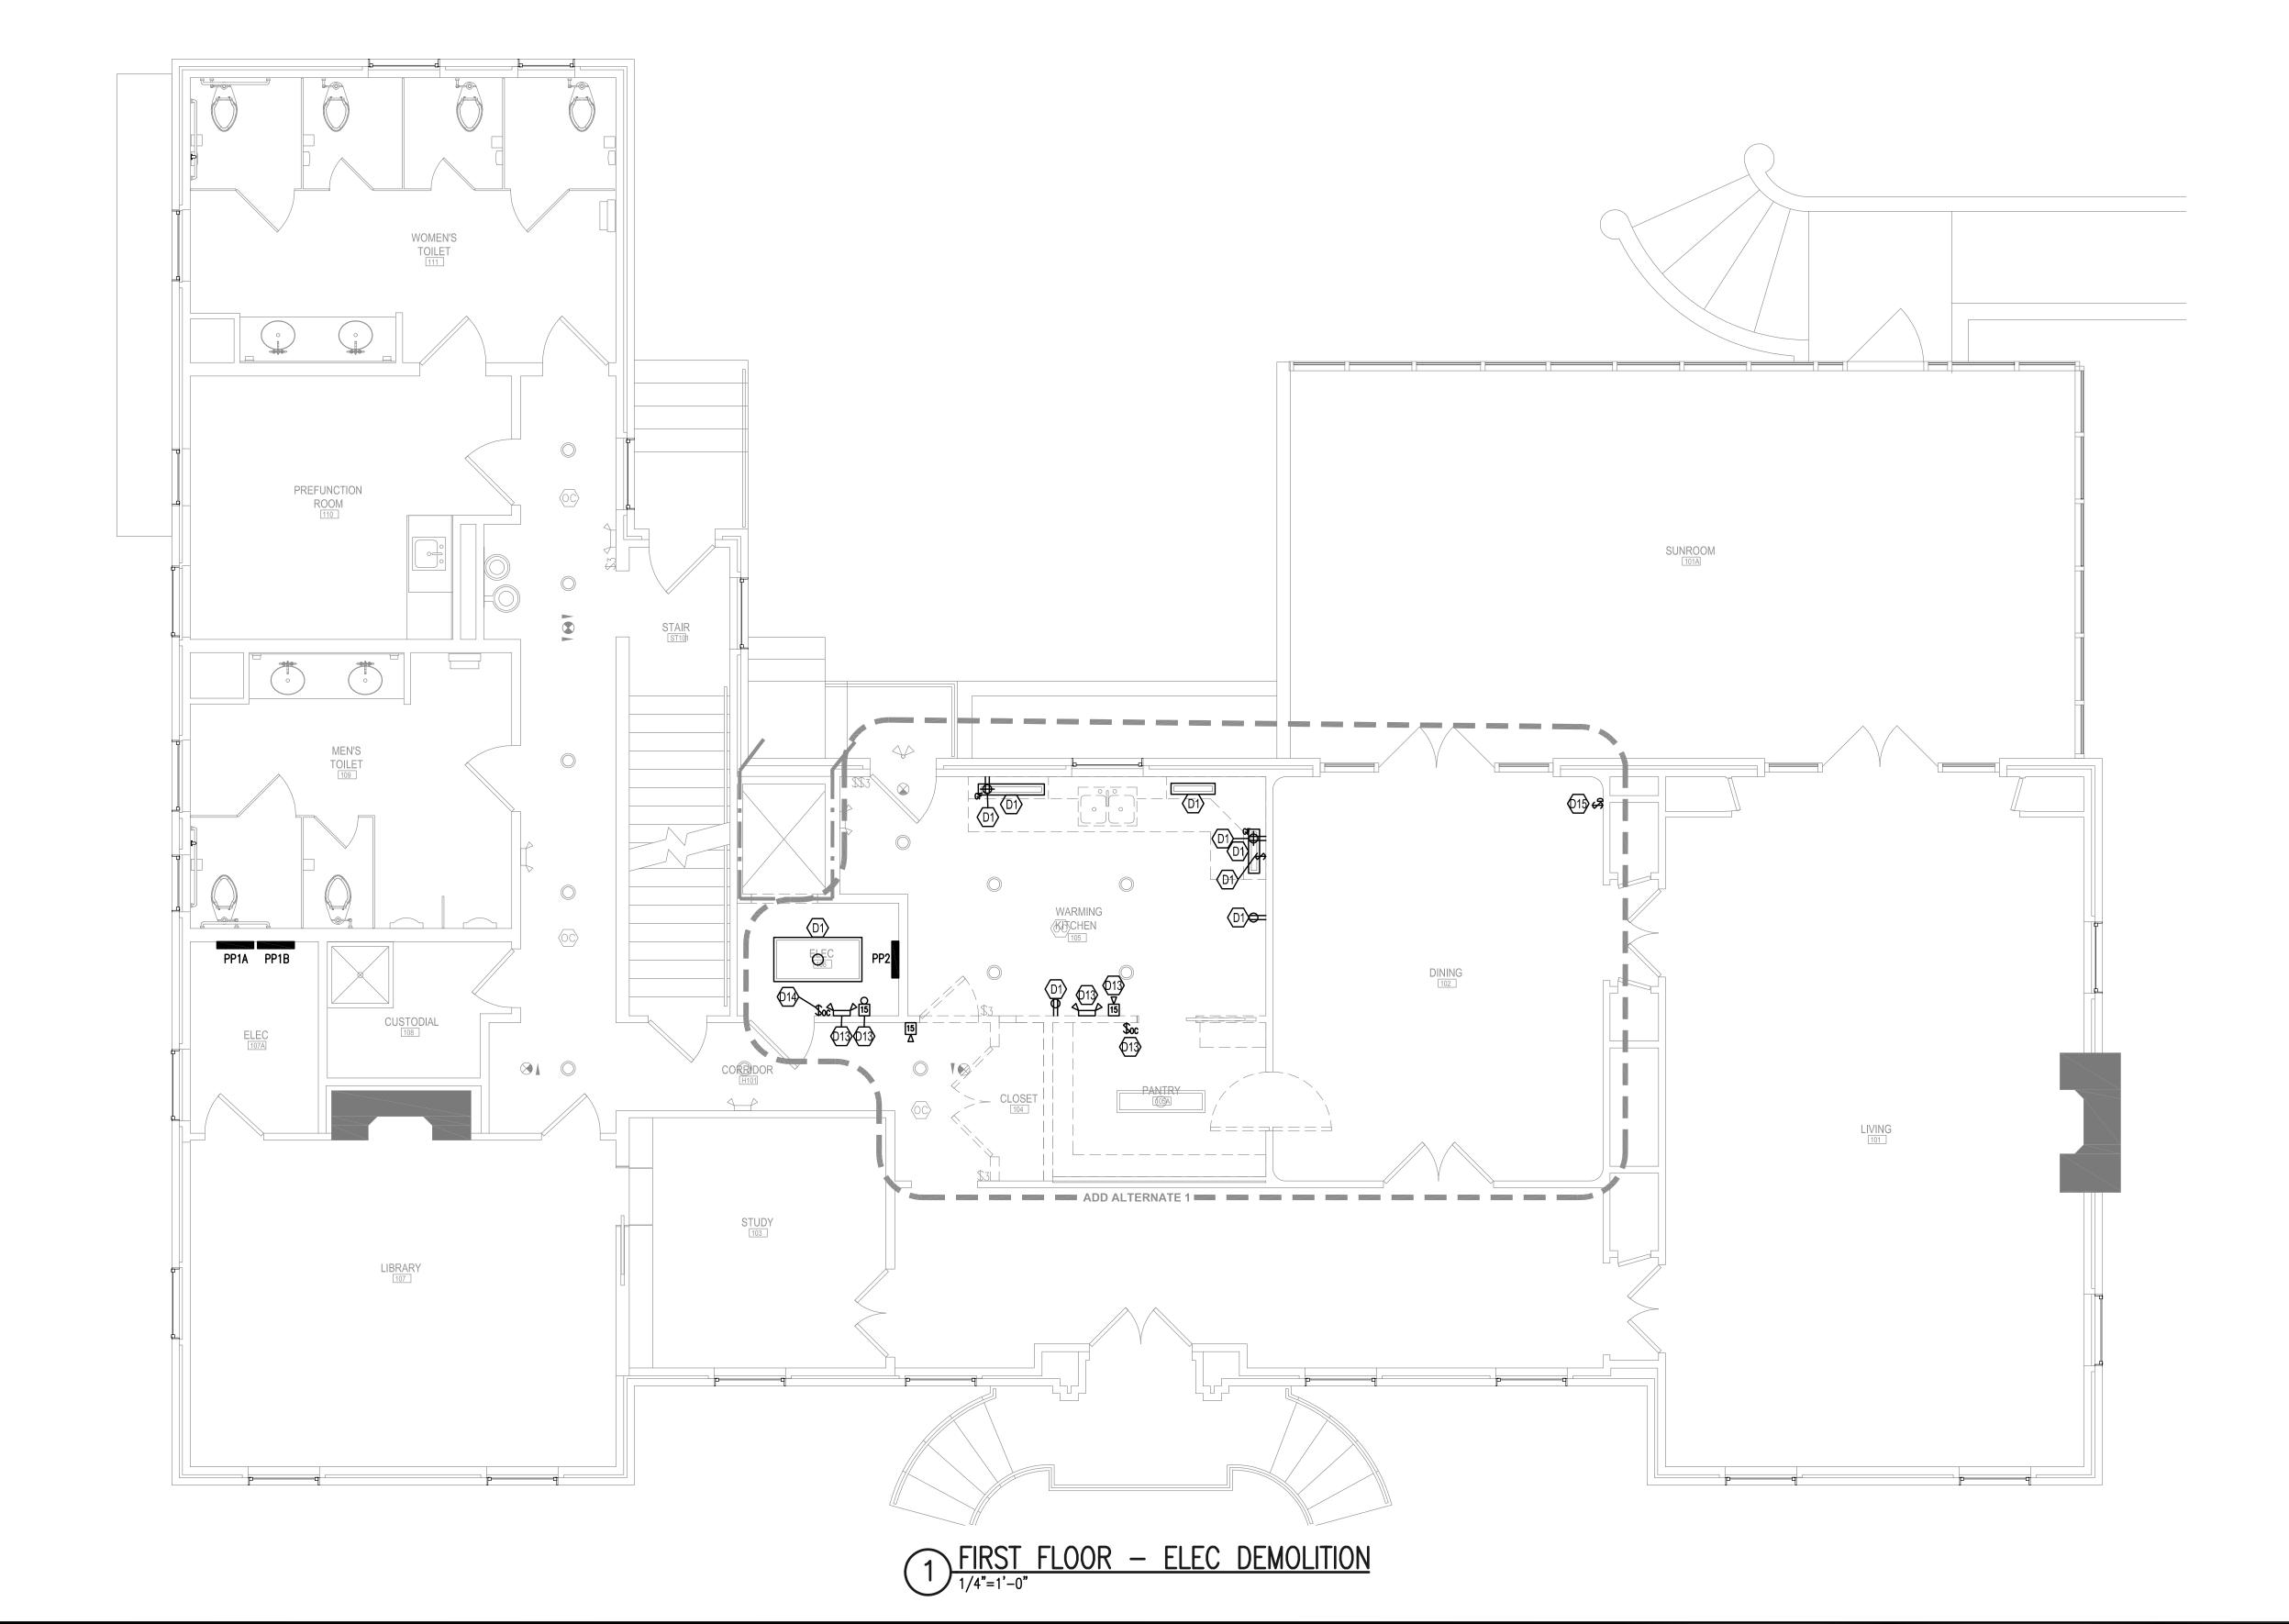

GENERAL DEMOLITION NOTES:

THE CONTRACTOR SHALL BE RESPONSIBLE FOR DISCONNECTION AND REMOVAL OF ANY ELECTRICAL DEVICES OR SYSTEMS AS REQUIRED FOR BUILDING ALTERATION WORK.
COORDINATE WITH ARCHITECTURAL DRAWINGS AND PROVIDE LABOR AND MATERIALS FOR
ALL WORK REQUIRED TO DISCONNECT DEVICES, LIGHT FIXTURES, ETC AT WALLS AND CEILINGS SCHEDULED FOR DEMOLITION.

WHERE DEVICES OR FIXTURES ARE REMOVED OR OTHERWISE MODIFIED TO ACCOMMODATE NEW CONSTRUCTION, THE CONTRACTOR SHALL BE RESPONSIBLE FOR VERIFYING ALL CONNECTIONS AND WIRING TO EXISTING BRANCH CIRCUITS AND DEVICES AND EXTENDING CIRCUITS AS REQUIRED TO MAINTAIN CONNECTIVITY TO EXISTING ADJACENT DEVICES AND FIXTURES TO REMAIN. NOTIFY OWNER PRIOR TO DISCONNECTION OR REMOVAL OF ANY ELECTRICAL SYSTEM DEVICE OR EQUIPMENT.

CONTRACTOR SHALL BE RESPONSIBLE FOR VERIFYING STYLES AND FINISHES OF EXISTING DEVICES, COVER PLATES, AND FIXTURES. NEW DEVICES AND EXIT SIGNS SHALL BE FURNISHED TO CLOSELY MATCH AESTHETIC CHARACTERISTICS OF EXISTING FIXTURES AND

WHERE DEVICES OR EQUIPMENT ARE ABANDONED OR DEMOLISHED AS PART OF THE SCOPE OF WORK, THE OWNER HAS FIRST RIGHT OF REFUSAL TO ALL EQUIPMENT, WIRING, AND MATERIALS DEMOLISHED. THE CONTRACTOR SHALL PROVIDE FOR PROPER DISPOSAL OF ALL EQUIPMENT AND MATERIALS NOT ACCEPTED BY THE OWNER. CONTRACTOR SHALL PROVIDE FOR REASONABLE TRANSPORTATION TO STORAGE FACILITY AS DIRECTED BY THE OWNER FOR ALL EQUIPMENT AND MATERIALS FOR WHICH THE OWNER CHOOSES TO RETAIN POSSESSION OF AFTER REMOVAL.

CONTRACTOR SHALL BE RESPONSIBLE FOR ALL PATCHING, PAINTING, ETC AS REQUIRED TO CLOSELY MATCH ADJACENT BUILDING FINISHES WHERE DEVICES OR EQUIOPMENT ARE

WHERE DEVICES OR FIXTURES ARE DEMOLISHED OR OTHERWISE ABANDONED AS PART OF THIS WORK, THE CONTRACTOR SHALL REMOVE ALL WIRING, RACEWAY, AND PERIPHERAL MATERIALS AND SUPPORTS TO SOURCE PANEL OR TO NEAREST JUNCTION BOX WHERE CIRCUIT SERVES OTHER DEVICES OR FIXTURES IN ADJACENT AREAS WHICH ARE TO REMAIN. FIELD COORDINATE.

REMOVE ALL CEILING MOUNTED DEVICES FROM CEILINGS BEING DEMOLISHED OR REWORKED AND REINSTALL AT SAME LOCATION OR NEW LOCATION AS DESCRIBED ON RENOVATION DRAWINGS. WHERE ANY NEW CEILINGS ARE LOWERED AND ARE BELOW LEVEL OF EXISTING WALL MOUNTED DEVICES, CONTRACTOR SHALL RELOCATE EXISTING DEVICES BELOW NEW CEILING LEVEL AND EXTEND WIRING/RACEWAY AS REQUIRED.

CAREFULLY REVIEW ARCHITECTURAL, MECHANICAL, AND PLUMBING DEMOLITION PLANS. EXAMINE WORK TO BE DONE AND PROVIDE ALL ELECTRICAL WORK AS REQUIRED FOR DEMOLITION OF WALLS, CEILINGS, EQUIPMENT, OR SIMILAR AS DESCRIBED IN CONTRACT DOCUMENT SET. THIS INCLUDES RELOCATION, REROUTING, ETC OF ELECTRICAL CIRCUITS OR INFRASTRUCTURE WHERE REQUIRED FOR WORK UNDER OTHER TRADES WHETHER SPECIFICALLY INDICATED ON ELECTRICAL DRAWINGS OR NOT. CONTRACTOR IS REQUIRED TO VISIT THE SITE PRIOR TO PLACING BID AND INCLUDE IN BID ANY LABOR AND MATERIALS ASSOCIATED WITH RELOCATION OR MODIFICATION OF EXISTING ELECTRICAL SYSTEMS WHICH MAY BE AFFECTED BY WORK IN THE AREAS OF RENOVATION OR ADJACENT BUILDING AREAS.

GENERAL NOTES NOT KEYED TO PLAN:

- (G1) EXISTING LIGHTING DEVICES IN PROJECT AREA TO REMAIN SHOWN AS LIGHTWEIGHT.
- DEMOLITION NOTES KEYED TO PLAN: DEMOLISH COMPLETE ALL EXISTING RECEPTACLES/LIGHT FIXTURES/LIGHT SWITCHES/STARTERS/DISCONNECTS/
- PANELBOARDS/BACKBOXES/J-BOX'S/PULL BOXES/CONDUITS ETC. IN/ON WALLS AND CEILINGS COMPLETE IN ALL SPACES/ROOMS. DEMOLISH ALL WIRING AND RACEWAY NO LONGER IN USE. ALL REMOVED EQUIPMENT SHALL BE TRANSPORTED TO THE OWNER'S STORAGE FACILITY BY THE CONTRACTOR. CONTRACTOR RESPONSIBLE FOR DISPOSAL FOR ALL MATERIALS REFUSED BY OWNER. FIELD COORDINATE EXACT LOCATION OF ALL EXISTING DEVICES.
- RECEPTACLE SHALL BE REMOVED. REMOVE RECEPTACLE, FACE PLATE, BACKBOX, AND CONDUCTORS COMPLETE. PATCH AND RECEPTACLE SHALL BE REMOVED. REMOVE RECEPTACLE, FACE I BALE, BACKET OF REMOVED. REPAIR WALL TO CONDITION OF REMAINING WALL WHERE EXISTING ELECTRICAL DEVICE IS REMOVED.
- RECEPTACLE SHALL BE REMOVED. REMOVE RECEPTACLE, FACE PLATE, AND CONDUCTORS COMPLETE.
- DISCONNECT EXISTING FEEDER FROM EXISTING HVAC UNIT. EXISTING DISCONNECT SWITCH AND FEEDER SHALL BE REMOVED. CONDUIT, WIRE, AND BACKBOX SHALL BE REMOVED COMPLETE. REMOVE EXISTING DEHUMIDIFIER ADJACENT TO AHU UNIT
- DATA OUTLET SHALL BE REMOVED. REMOVE OUTLET, FACE PLATE, AND BACKBOX COMPLETE. PATCH AND REPAIR WALL TO CONDITION OF REMAINING WALL WHERE EXISTING ELECTRICAL DEVICE IS REMOVED.
- DATA OUTLET SHALL BE REMOVED. REMOVE OUTLET AND FACE PLATE.
- DEMOLISH COMPLETE ALL EXISTING LIGHT FIXTURES IN SPACE. DEMOLISH ALL CONDUCTORS, SURFACE RACEWAY, AND BACKBOX TO SOURCE PANEL. PATCH AND REPAIR WALL TO CONDITION OF REMAINING WALL WHERE EXISTING FIXTURE IS
- LIGHT SWITCH SHALL BE REMOVED. REMOVE SWITCH, FACE PLATE, BACKBOX, AND CONDUCTORS COMPLETE. PATCH AND REPAIR WALL TO CONDITION OF REMAINING WALL EXISTING ELECTRICAL DEVICE IS REMOVED.
- LIGHT SWITCH SHALL BE REMOVED. REMOVE LIGHT SWITCH, FACE PLATE, AND CONDUCTORS COMPLETE.
- REMOVE BACKBOX AND FACE PLATE COMPLETE. PATCH AND REPAIR WALL TO CONDITION OF REMAINING WALL WHERE EXISTING ELECTRICAL DEVICE IS REMOVED.
- EXISTING TELECOMMUNICATIONS DEVICE AND ALL ASSOCIATED DATA WIRING SHALL REMAIN AS—IS AND BE PROTECTED DURING DEMOLITION.
- 612 LIGHT FIXTURE SHALL BE REMOVED. REMOVE FIXTURE AND CONDUCTORS COMPLETE.
- (13) EXISTING DEVICE TO BE REMOVED AND RELOCATED TO NEW LOCATION SHOWN ON RENOVATION PLAN.
- (\$\dagger\$) EXISTING SWITCH TO REMAIN. TIE INTO NEW LIGHT FIXTURES AS SHOWN ON RENOVATION PLAN.
- ©15 EXISTING SWITCH TO BE RELOCATED TO NEW LOCATION.

REQUIRED WORK SEQUENCE: A. Construct Work in stages during construction period:

- 1. Stage 1: [2nd Floor alterations]. Achieve full certificate of occupancy, including life safety system operational
- inspection and all other final completion requirements, by October 16, 2019. 2. Stage 2: [1st Floor alterations (if alternate is accepted)]. Achieve full certificate of occupancy, including life safety system operational inspection and all final completion
- requirements, within 105 calendar days from the Date of Commencement. . Coordinate construction schedule and operations with Owner. Work on the 1st floor that supports the Work on the 2nd floor functionally (such as ducts, shafts, vertical piping and infrastructure, etc.) is to be included in Stage 1 work.

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project name BARRINGER HOUSE **RENOVATIONS**

seals/signature

State project number PROJECT # FP00000285 GMK project number PROJECT # 16070.03/H27-D339-ID





CONSTRUCTION DOCUMENTS


AUGUST 2, 2019


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ELECTRICAL DEMOLITION FIRST AND SECOND **FLOOR PLANS**

sheet number

drawn by RMI checked by RMI



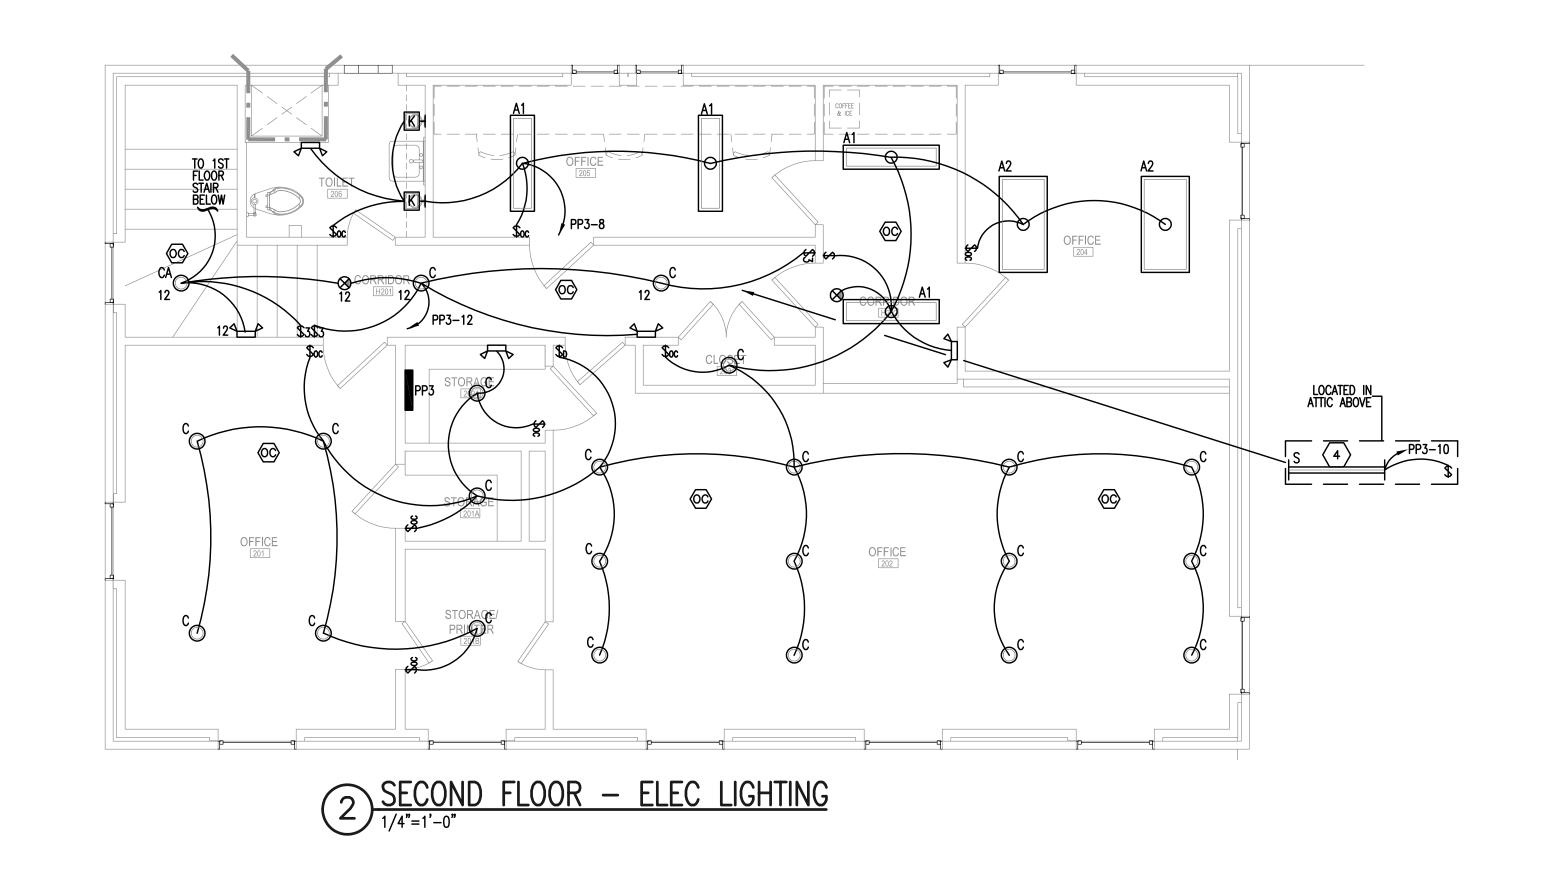

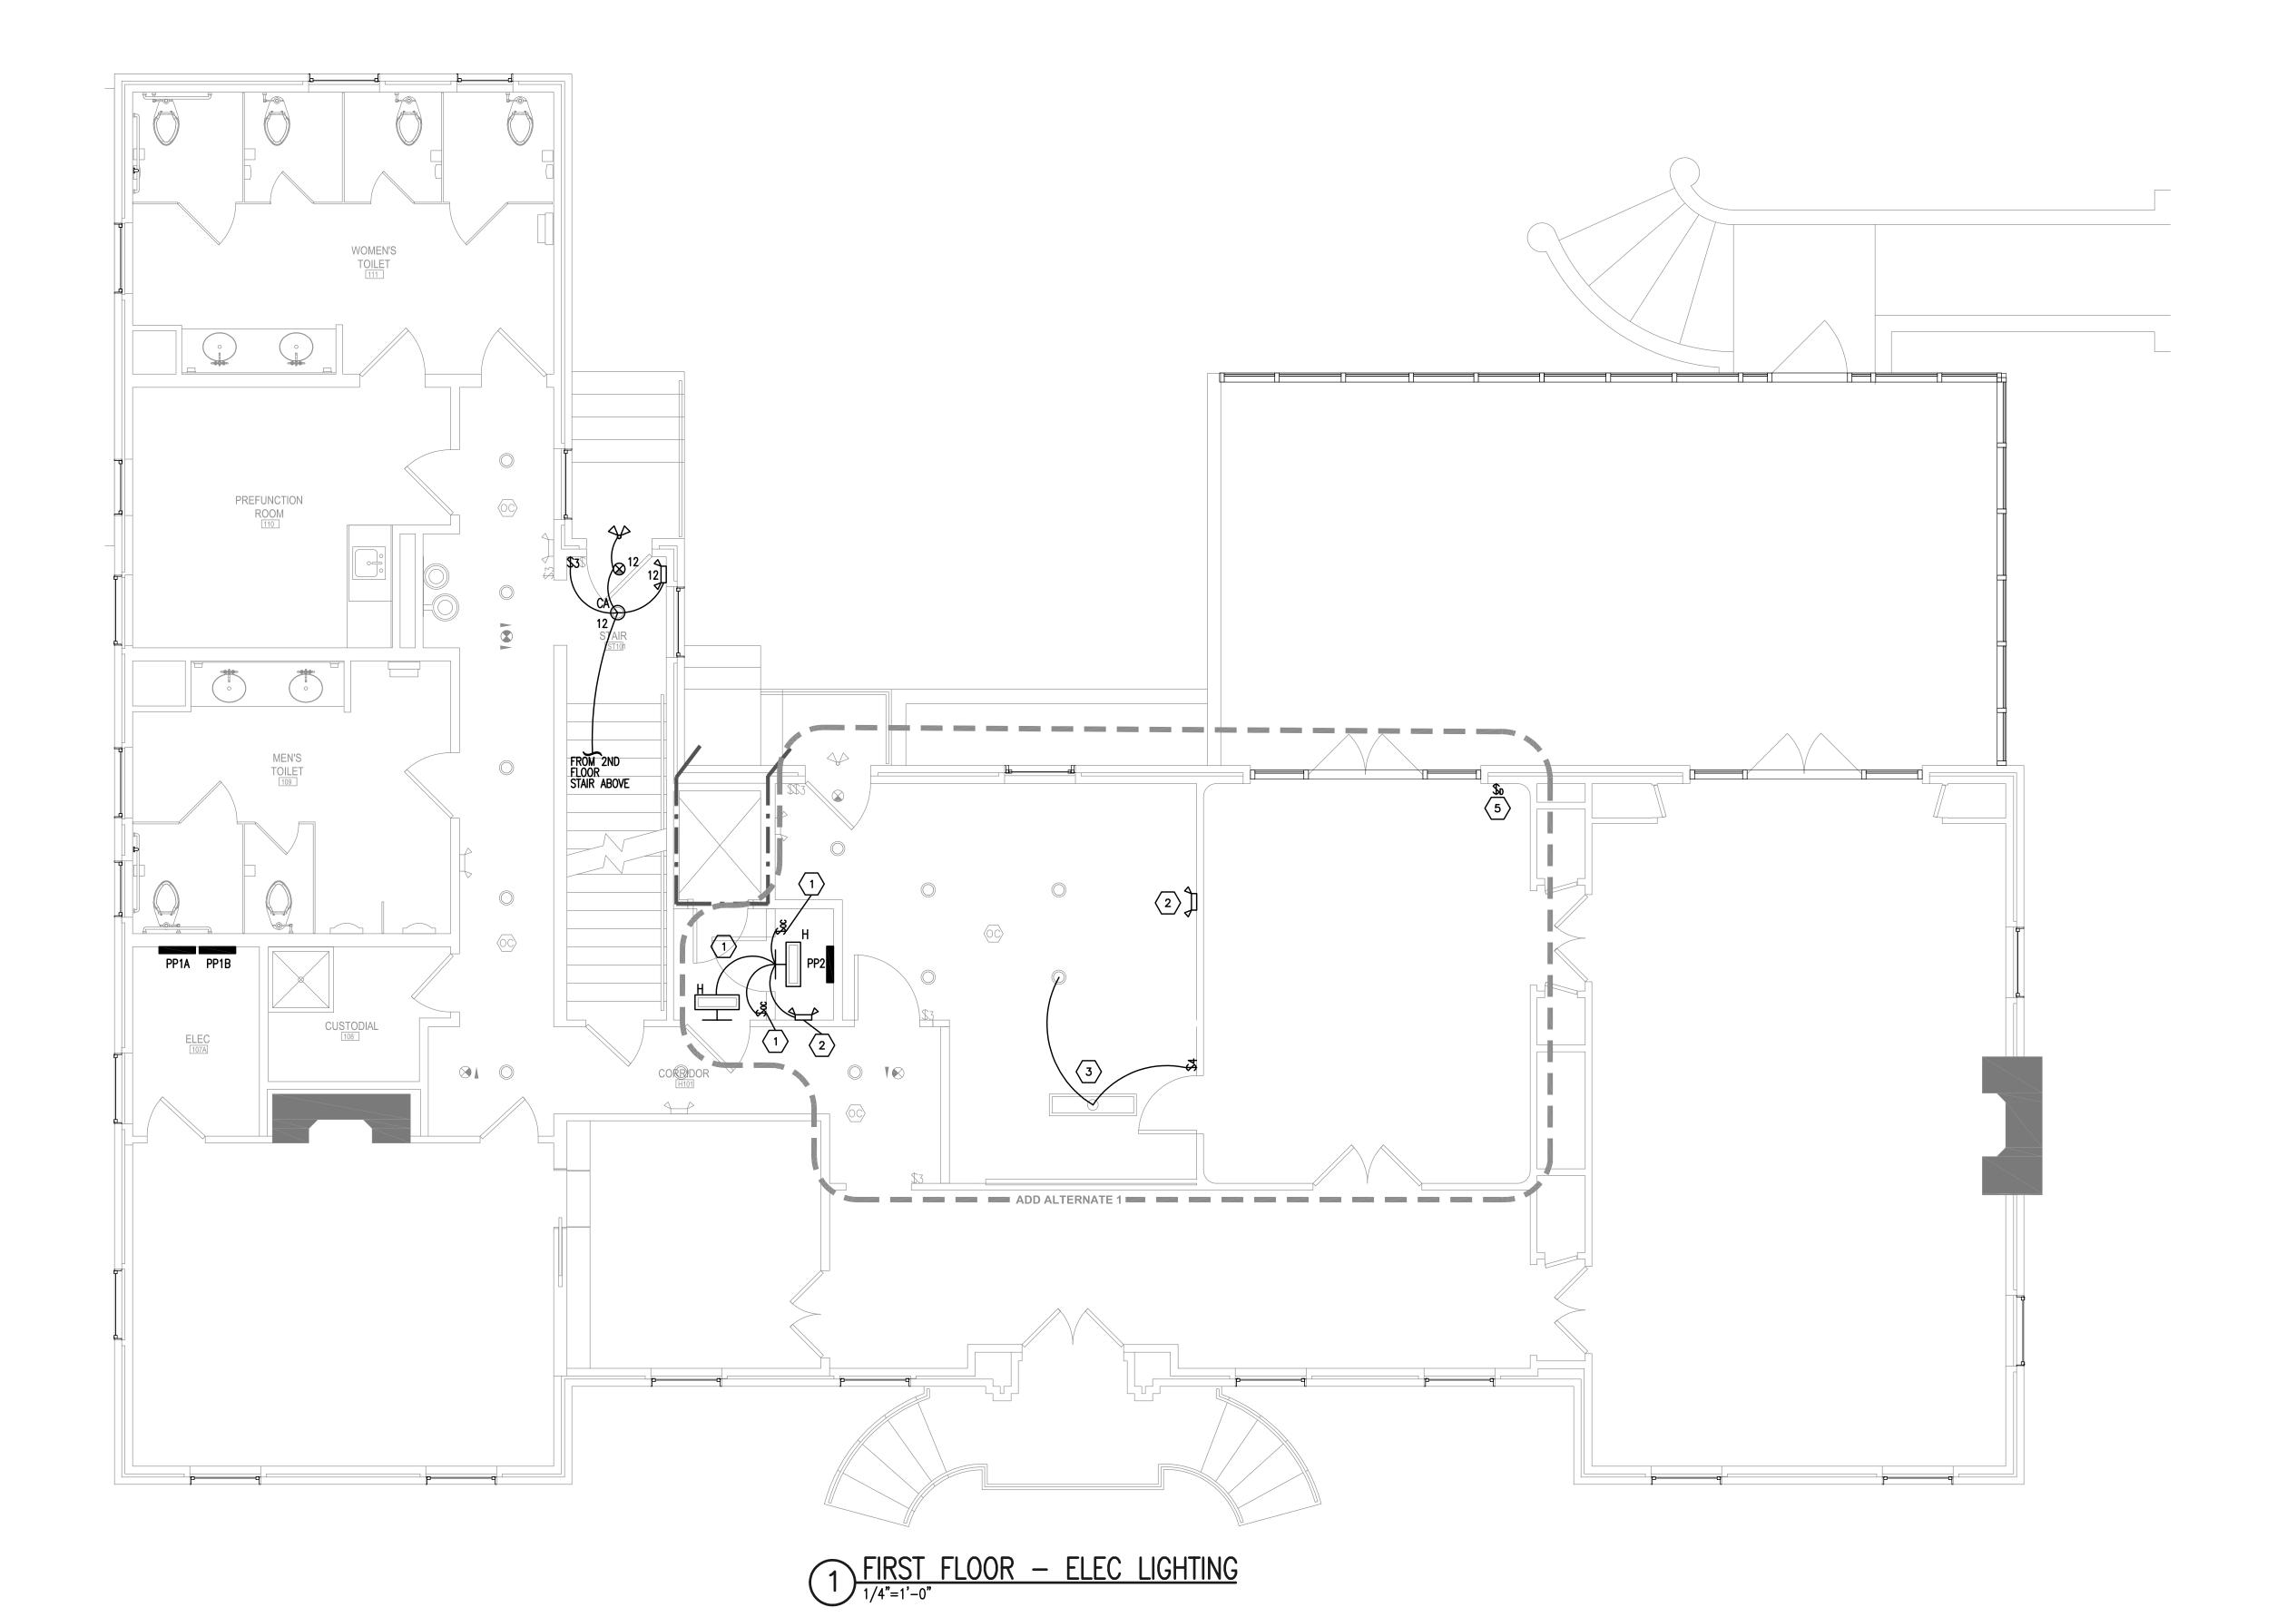GENERAL NOTES NOT KEYED TO PLAN:

EXISTING FIXTURES TO REMAIN AS IS ARE SHOWN LIGHTWEIGHT.

LIGHTING NOTES KEYED TO PLAN:

- RELOCATE EXISTING OCCUPANCY SENSOR SWITCH REMOVED DURING DEMOLITION TO NEW LOCATION SHOWN. TIE INTO NEW LIGHTING FIXTURES AND SWITCH AS SHOWN. NEW LIGHTING FIXTURES SHALL BE TIED INTO EXISTING LIGHTING CIRCUIT PP2-13.
- RELOCATE EXISTING EMERGENCY FIXTURE REMOVED DURING DEMOLITION TO NEW LOCATION SHOWN. TIE FIXTURE INTO EXISTING LIGHTING CIRCUIT PP2-13.
- PROVIDE NEW 4 WAY LIGHT SWITCH AND TIE EXISTING SURFACE MOUNTED FIXTURE INTO KITCHEN LIGHTING CIRCUIT. ALL FIXTURES IN SPACE SHALL BE CONTROLLED BY THE NEW 4 WAY SWITCH AND EXISTING 3 WAY SWITCHES
- INSTALL (4) FIXTURES IN ATTIC. MOUNT FIXTURE DIRECTLY TO STRUCTURE IN ATTIC. COORDINATE WITH MC TO AVOID ALL MECHANICAL EQUIPMENT THAT MAY INTERFERE WITH PROPER LIGHTING OF SPACE. LOCATE ATTIC LIGHT SWITCH AT ENTRANCE OF ATTIC DOOR. COORDINATE.
- RELOCATE EXISTING LIGHTING SWITCH TO NEW LOCATION SHOWN. EXTEND EXISTING WIRING AND CONDUIT AS REQUIRED.



ARCHITECT WILL BE SUBJECT TO LEGAL ACTION.

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AUGUST 2, 2019

number	item	date

key plan



sheet title
ELECTRICAL LIGHTING
FIRST AND SECOND
FLOOR PLAN

sheet number

E2.1

drawn by RMI checked by RMI

REQUIRED WORK SEQUENCE:


A. Construct Work in stages during construction period:
1. Stage 1: [2nd Floor alterations]. Achieve full certificate of occupancy, including life safety system operational inspection and all other final completion requirements, by October 16, 2019.
2. Stage 2: [1st Floor alterations (if alternate is accepted)]. Achieve full certificate of occupancy, including life safety system operational inspection and all final completion

requirements, within 105 calendar days from the Date of Commencement.

B. Coordinate construction schedule and operations with Owner.

C. Work on the 1st floor that supports the Work on the 2nd floor functionally (such as ducts, shafts, vertical piping and

infrastructure, etc.) is to be included in Stage 1 work.

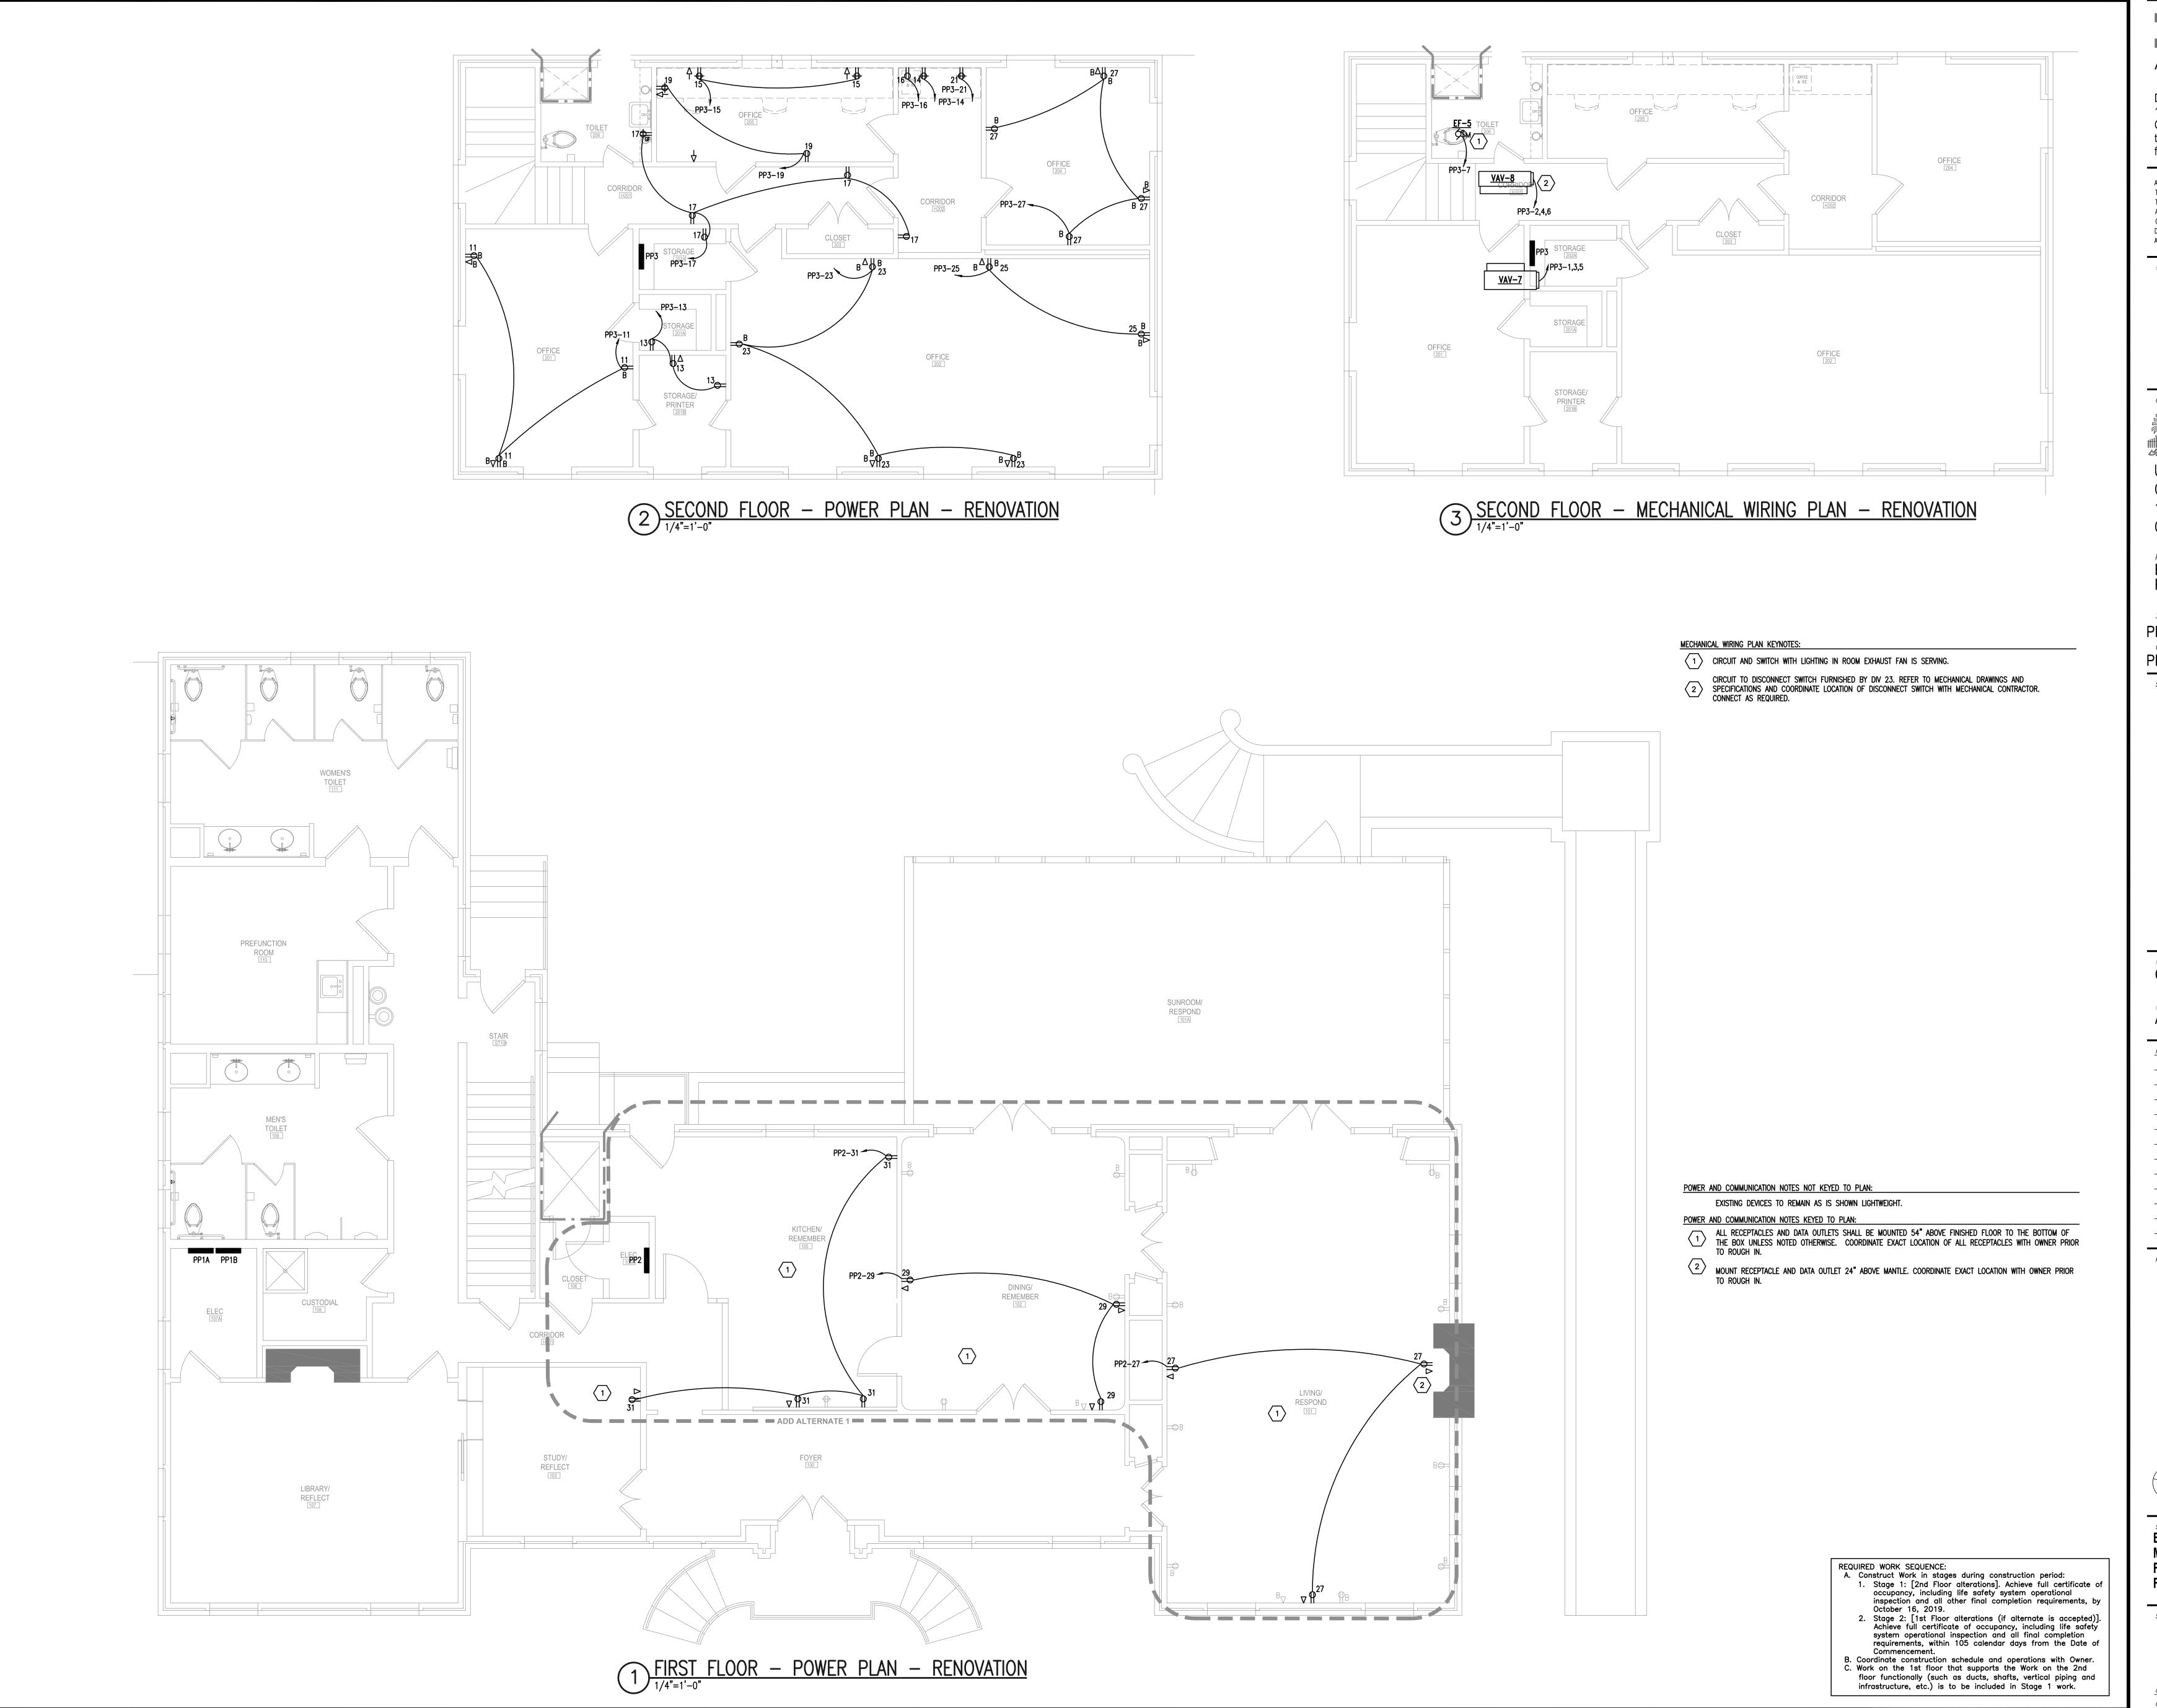

III GMK

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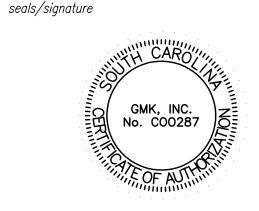
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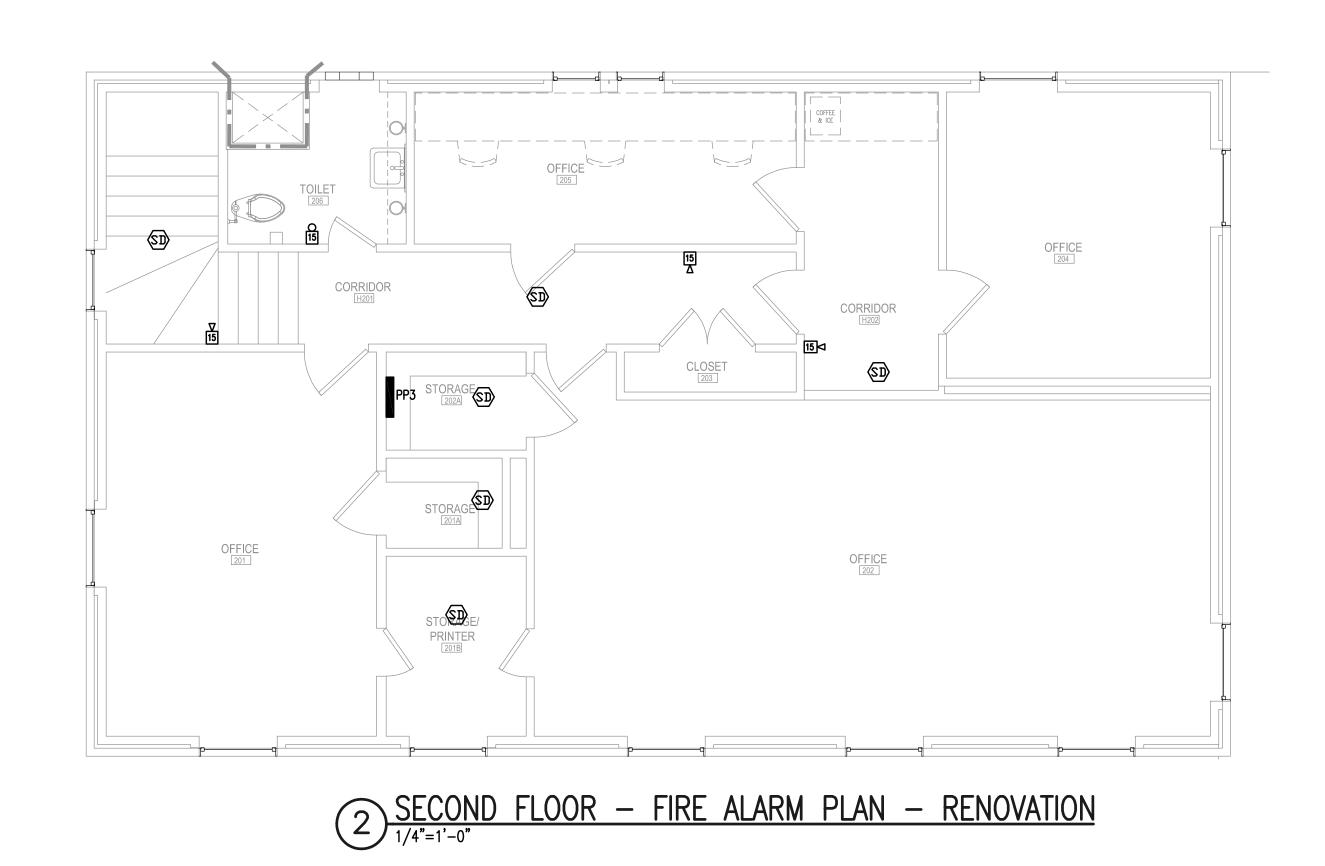


sheet title
ELECTRICAL POWER AND
MECHANICAL WIRING
FIRST AND SECOND
FLOOR PLANS

sheet number

E3.1

drawn by RMI
checked by RMI



FIRE ALARM NOTES KEYED TO PLAN:

- 1 EXISTING FIRE ALARM DEVICES IN RENOVATION AREA TO REMAIN ARE SHOWN LIGHTWEIGHT.
- RELOCATE EXISTING DEVICE REMOVED DURING DEMOLITION TO NEW LOCATION SHOWN. EXTEND EXISTING CONDUIT AND WIRING TO NEW LOCATION.

FIRE ALARM SYSTEM PARTIAL RENOVATION AND EXTENSION GENERAL NOTES:

REQUIRED BY ARCHITECT.

- INCLUDE IN BID ALL LABOR, MATERIALS, PROGRAMMING, ETC AS REQUIRED FOR COMPLETE SYSTEM IN ACCORDANCE WITH THE INTENT OF THESE DRAWINGS. CONTRACTOR SHALL FURNISH AND INSTALL ALL COMMUNICATIONS PATHWAYS AS REQUIRED FOR A COMPLETE SYSTEM. COORDINATE ALL PATHWAY LOCATIONS PRIOR TO ANY ROUGH-INS. IF CONDITIONS REQUIRE CONDUIT OR RACEWAY TO BE RUN EXPOSED COORDINATE ROUTING WITH ARCHITECT AND PAINT AS
- ALL NEW DEVICES SHALL BE COMPATIBLE WITH THE EXISTING SYSTEM AND NOTIFICATION APPLIANCES SHALL BE CAPABLE OF STROBE SYNCHRONIZATION WITH THE EXISTING DEVICES TO REMAIN IN ALL AREAS.
- CONTRACTOR SHALL BE RESPONSIBLE FOR SUBMITTING TO ENGINEER AND TO AHJ ALL REQUIRED CALCULATIONS AND DETAILS OF RENOVATED SYSTEM. THIS INCLUDES BUT IS IN NO WAY LIMITED TO, POINT TO POINT WIRING DIAGRAMS, REVISED VOLTAGE DROP CALCULATIONS, REVISED BATTERY CALCULATIONS, AND ALL ADDITIONAL DOCUMENTATION REQUIRED FOR APPROVAL BY THE AHJ FOR THE COMPLETE SYSTEM AFTER RENOVATION.
- PROVIDE ADDITIONAL POWER SUPPLIES, NAC EXTENDER PANELS, OR SIMILAR AUXILIARY EQUIPMENT AS REQUIRED FOR ADDITION OF NEW DEVICES AND RELOCATION OF EXISTING DEVICES AT LOCATIONS REFERENCED ON DRAWINGS.
- ONLY DEVICES AFFECTED IN AREAS OF RENOVATION ARE INDICATED ON DRAWINGS. THE CONTRACTOR IS RESPONSIBLE FOR VERIFYING LOCATION AND
- CIRCUITING OF ALL DEVICES IN ADJACENT AREAS TO MAINTAIN OPERATION OF SYSTEM DURING AND AFTER RENOVATION. APPROVAL AND PERMIT SHALL BE OBTAINED BY THE AHJ PRIOR TO COMMENCING ANY WORK.
- PROVIDE RECORD OF COMPLETION TO ENGINEER AND AHJ PER NFPA 72. EXISTING FIRE ALARM SYSTEM MANUFACTURER: GAMEWELL FCI



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project name BARRINGER HOUSE RENOVATIONS

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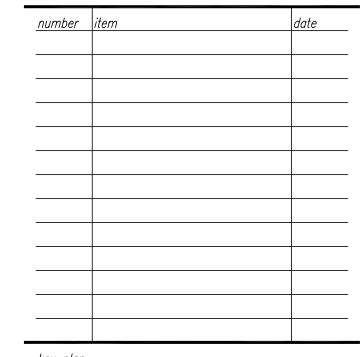
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AUGUST 2, 2019





ELECTRICAL FIRE ALARM FIRST AND SECOND **FLOOR PLANS**

sheet number

REQUIRED WORK SEQUENCE:

Commencement.

A. Construct Work in stages during construction period:

1. Stage 1: [2nd Floor alterations]. Achieve full certificate of occupancy, including life safety system operational inspection and all other final completion requirements, by October 16, 2019.

2. Stage 2: [1st Floor alterations (if alternate is accepted)].
Achieve full certificate of occupancy, including life safety system operational inspection and all final completion

B. Coordinate construction schedule and operations with Owner. C. Work on the 1st floor that supports the Work on the 2nd floor functionally (such as ducts, shafts, vertical piping and infrastructure, etc.) is to be included in Stage 1 work.

requirements, within 105 calendar days from the Date of

drawn by RMI checked by RMI

